JOHNSON CONTROLS, INC

CITY OF GLENDALE, WISCONSIN OAK LEAF TRAIL CONNECTOR PATH BID PACKAGE



One Honey Creek Corporate Center 125 South 84th Street, Suite 401 Milwaukee, WI 53214-1469 414 / 259 1500 414 / 259 0037 fax

www.graef-usa.com

CONSULTANTS:

PROJECT TITLE:

UTILITY CONTACTS:

MILWAUKEE COUNTY DEPT. OF PARKS. RECREATION & CULTURE 9480 WATERTOWN PLANK RD. WAUWATOSA, WI 53226 ATTN: MR. KEVIN HALEY PHONE: (414) 257-6242 KEVIN.HALEY@MILWAUKEECOUNTYWI.GOV

CITY OF GLENDALE 5909 N. MILWAUKEE RIVER PARKWAY GLENDALE, WI 53209 ATTN: MR. DAVE EASTMAN PHONE: (414) 228-1746 D.EASTMAN@GLENDALE-WI.ORG

AMERICAN TRANSMISSION COMPANY PO BOX 47 WAUKESHA, WI 53187-00472 ATTN: MS. TONY MARCINIAK PHONE: (262) 506-6814 (OFFICE)

AMERICAN TRANSMISSION COMPANY (ATC) NOTES:

- 1. THERE ARE MULTIPLE 138,000 VOLT TRANSMISSION LINES WITHIN THE EASEMENT. MAINTAIN A SAFE WORKING CLEARANCE TO THE CONDUCTORS AT ALL TIMES BASED ON THE LATEST OSHA REQUIREMENTS.
- 2. EXERCISE CAUTION WHEN WORKING AND DRIVING NEAR TRANSMISSION LINE STRUCTURES TO AVOID DAMAGE. ANY DAMAGE TO ATC FACILITIES BY THE CONTRACTOR IS RESPONSIBLE FOR THE COST OF REPAIRS AND MUST BE REPORTED IMMEDIATELY TO CHRIS DAILEY (MAINTENANCE DEPARTMENT) BY CALLING (262) 506-6884.
- 3. UNOBSTRUCTED ATC ACCESS TO THE TRANSMISSION LINES AND TOWERS MUST BE MAINTAINED AT ALL TIMES.
- 4. NO STOCKPILING OR STAGING OF EQUIPMENT OR MATERIALS UNDER OR NEAR THE ATC TRANSMISSION LINES AND
- 5. CONTACT DIGGERS HOTLINE AT LEAST 3 WORKING DAYS PRIOR TO ANY EXCAVATION WITHIN THE EASEMENT.
- 6. NO EXCAVATION WITHIN 20-FEET OF THE FACE OF ANY STRUCTURE EXCEPT FOR MINOR SURFACE EXCAVATION FOR TRAIL CONSTRUCTION. FILL MAY NOT BE PLACED AGAINST ANY STRUCTURE.
- 7. TRANSMISSION LINE STRUCTURES MAY HAVE MULTIPLE GROUND RODS. THESE GROUND RODS COULD BE LOCATED A SIGNIFICANT DISTANCE FROM THE STRUCTURE. ALL GROUND RODS ARE CONNECTED TO THE STRUCTURE VIA A GROUND WIRE AND COULD BE BURIED UP TO A DEPTH OF EIGHTEEN (18) INCHES OR MORE. IF THE GROUND RODS ARE DISTURBED THROUGH CONSTRUCTION ACTIVITIES, THE LOCATION MUST BE NOTED AND PROMPTLY REPORTED TO THE ATC MAINTENANCE DEPARTMENT. THE COST OF ALL REPAIRS TO GROUND RODS/WIRES IS THE RESPONSIBILITY OF THE CONTRACTOR.
- 8. ELECTRIC FIELDS FROM TRANSMISSION LINES CAN CAUSE INDUCED VOLTAGE AND CURRENT ON INSUFFICIENTLY GROUNDED EQUIPMENT THAT IS NEAR THE LINE (SUCH AS LARGER VEHICLES). THIS CAN BE UNCOMFORTABLE TO PEOPLE AND LIVESTOCK WHO COME IN CONTACT WITH IT, AND CAUSE INTERFERENCE TO CERTAIN ELECTRICAL DEVICES. THE CONTRACTOR WOULD BE RESPONSIBLE FOR INSTALLING ANY GROUNDING OR MITIGATION DEVICES NECESSARY ON THEIR EQUIPMENT TO
- 9. GRADE CHANGES IN EXCESS OF ONE FOOT SHALL BE REVIEWED AND APPROVED BY T-LINE SERVICES. TRANSITION SLOPES FOR GRADE CHANGES SHOULD BE 4' TO 1' VERTICAL FOR STEEL TOWERS AND POLES; 3' HORIZONTAL TO 1' VERTICAL FOR WOOD POLES AND WOOD H-FRAME STRUCTURES.
- 10. SIGNS AND MARKERS MAY NOT BE ATTACHED TO ATC STRUCTURES. SMALL SIGNS OR MARKERS MAY NOT BE PLACED ON THE GROUND WITHIN 10 FEET OF ANY STRUCTURE. THE LARGE BILLBOARD TRAIL SIGNS MAY NOT BE PLACED WITHIN 30-FEET OF ANY TRANSMISSION STRUCTURE AND MAY NOT OBSTRUCT ACCESS TO THE WE ENERGIES ROW.
- 11. THREE FEET OF SPACE BETWEEN THE PAVED PORTION OF THE TRAIL AND THE BASE OF THE ATC STRUCTURE.

SHEET INDEX

C001	TITLE SHEET
C100	TOPOGRAPHIC SURVE

SITE DEMOLITION AND EROSION C200

CONTROL PLAN

SITE LAYOUT, GRADING AND C300

DRAINAGE PLAN

SITE CONSTRUCTION DETAILS C900 C901 SITE CONSTRUCTION DETAILS

JOHNSON CONTROLS, INC OAK LEAF TRAIL CONNECTOR

5757 N GREEN BAY AVE GLENDALE, WISCONSIN

REVISIONS

GLENDALE

MILWAUKEE

LEGEND

TRAVERSE POINT REBAR LIGHT POLE ELECTRIC TRANSFORMER

CONTROL BOX PULL BOX GATE POST o GATE

CLEANOUT CATCH BASIN ELECTRIC RISER

FLAG POLE o FLAG SIGN

FIRE HYDRANT METAL POST DECIDUOUS TREE

CONIFEROUS TREE

BUSH LINE — E— — — BURIED ELECTRIC LINE

-stm - - - - BURIED STORM SEWER

TOPOGRAPHIC SURVEY

SHEET NUMBER:

PROJECT INFORMATION:

9/24/15

AS SHOWN

C_00_C000_COVER-011

SHEET TITLE:

PROJECT NUMBER: 20151011.00

DATE:

DRAWN BY


FILE PATH:

CHECKED BY:

APPROVED BY:

In accordance with Wisconsin statute 182.0175, damage to transmission facilities, excavator shall be solely responsible to provide advance notice to the designated "ONE CALL SYSTEM" not less than three working days prior to commencement of any excavation required to perform work contained on this drawing, and further, excavator shall comply with all other requirements of this statute relative to excavator's work.

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EROSION CONTROL NOTES

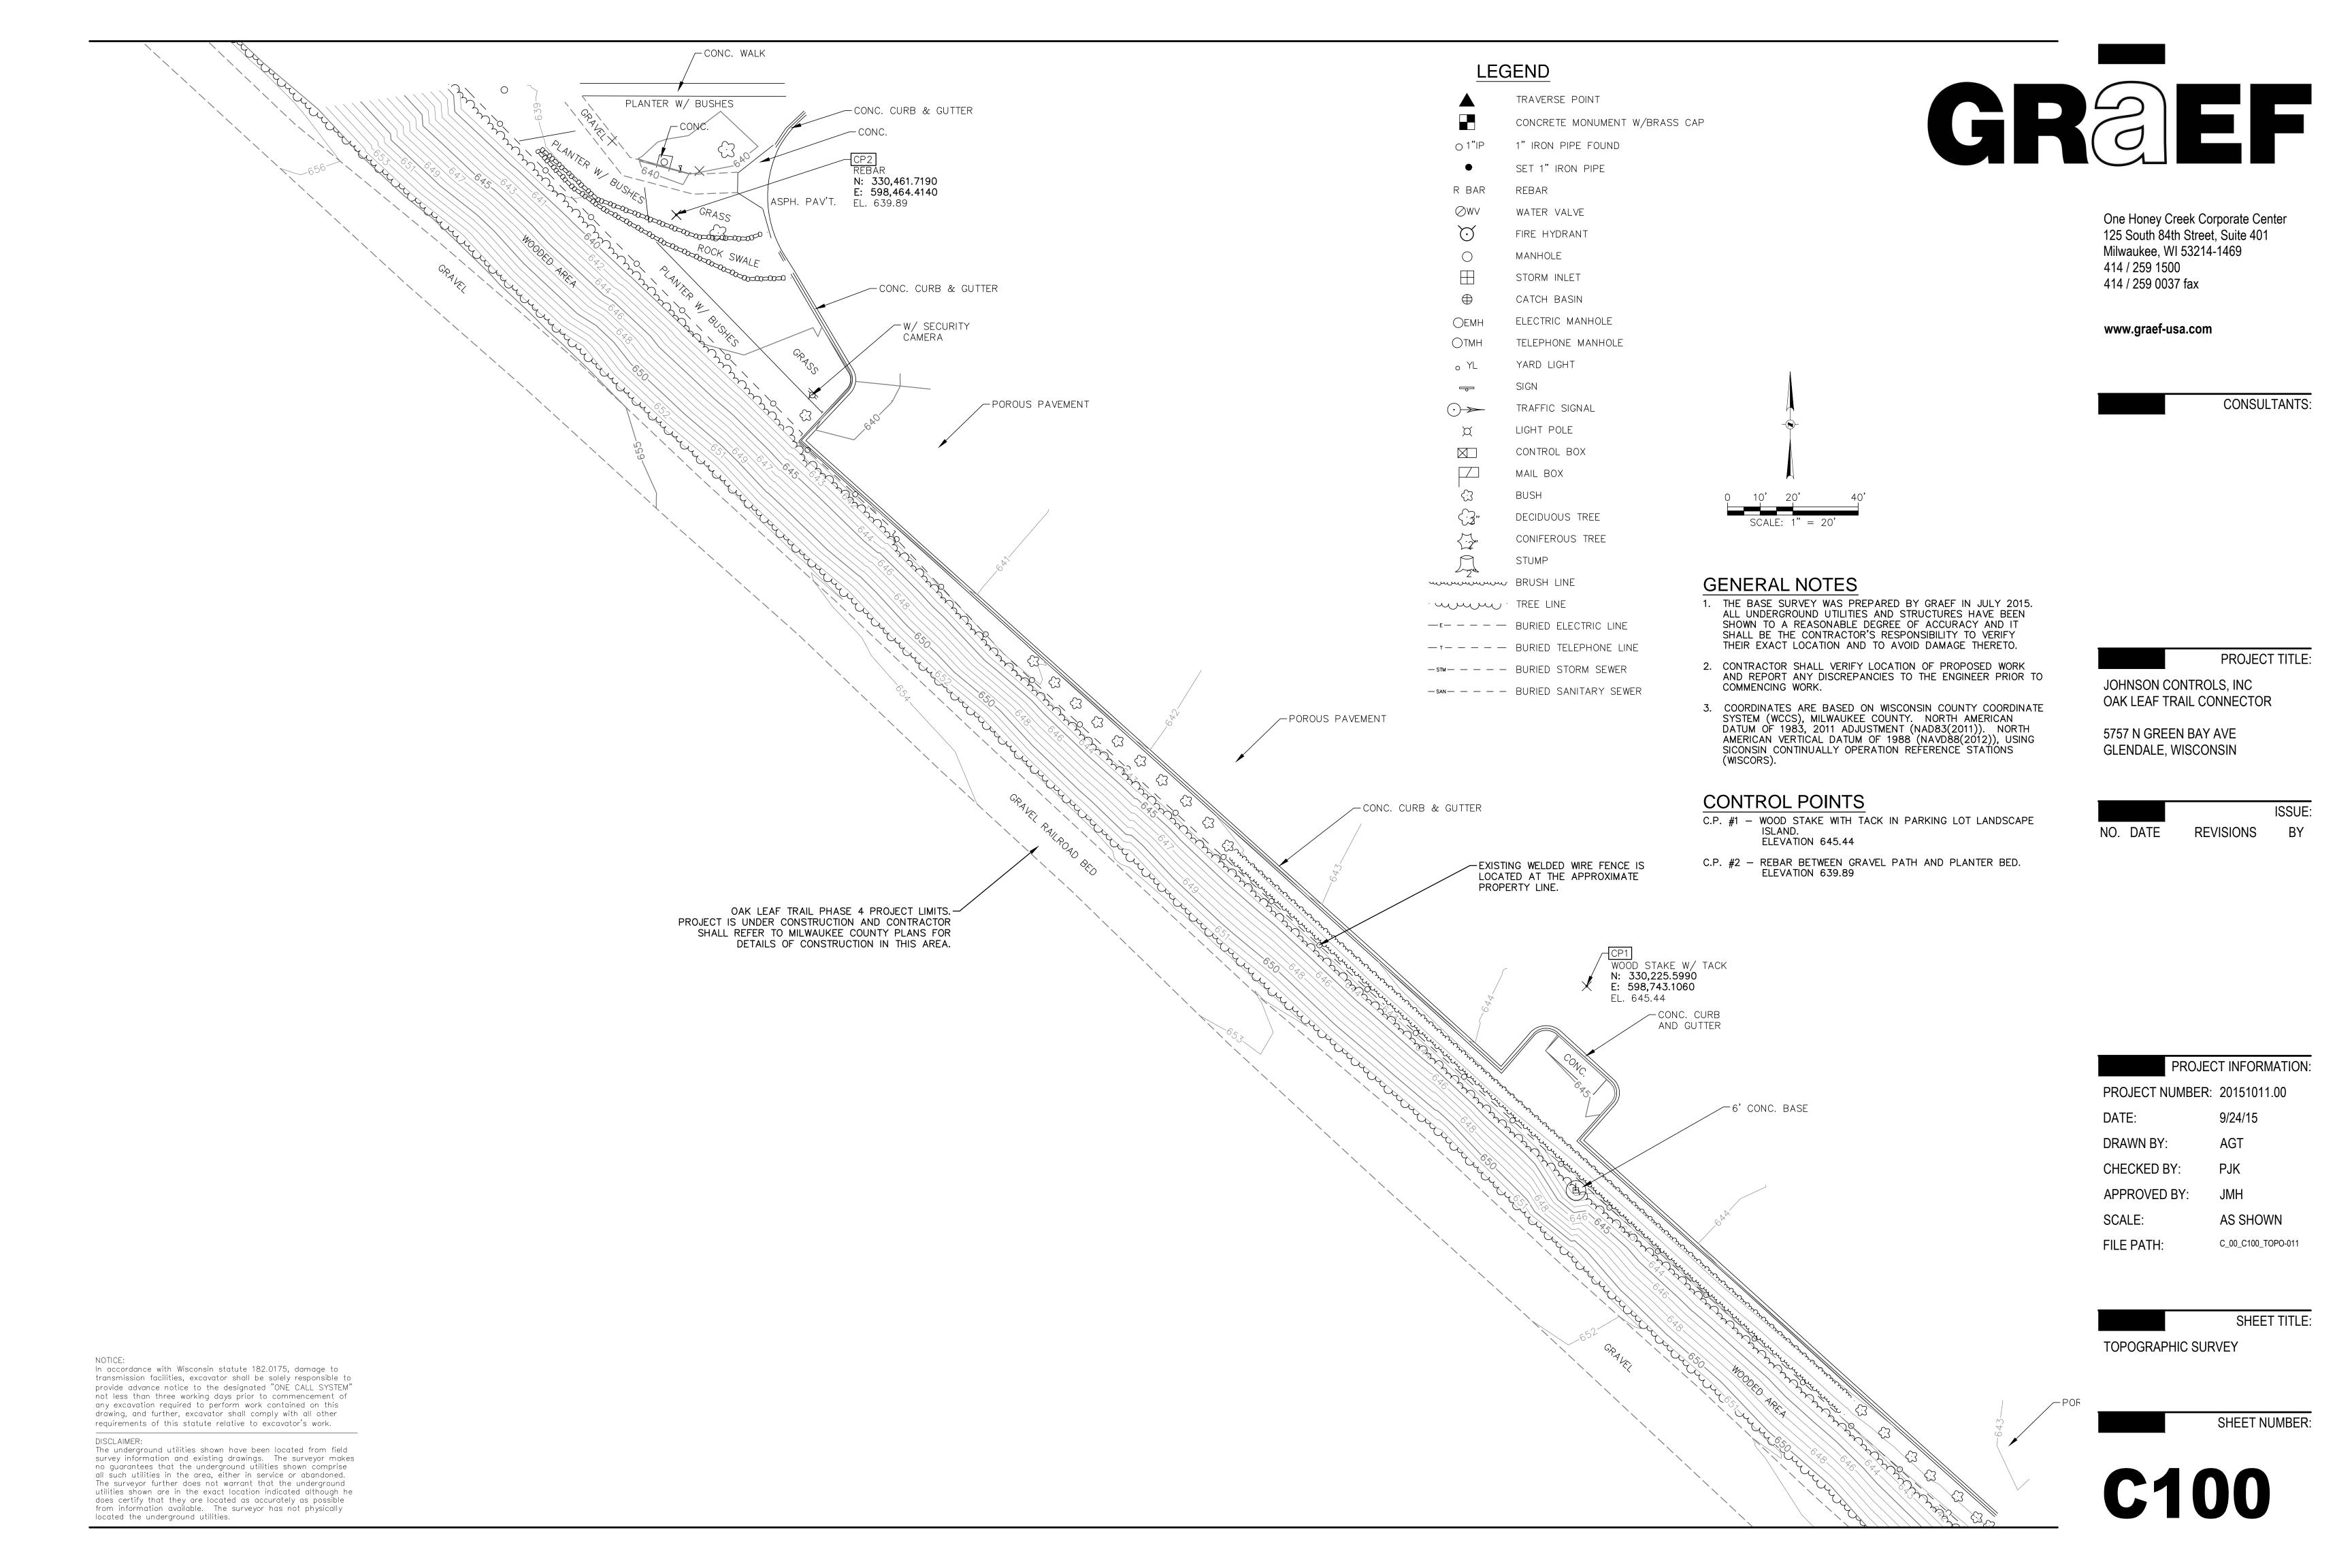- 1. CONSTRUCTION SITE EROSION CONTROL AND SEDIMENTATION CONTROL SHALL COMPLY WITH THE REQUIREMENTS OF THE CITY OF GLENDALE, AND SHALL EMPLOY EROSION CONTROL METHODS AS SHOWN AND SPECIFIED IN THE WISCONSIN DEPARTMENT OF NATURAL RESOURCES (WDNR) "CONSTRUCTION SITE EROSION AND SEDIMENT CONTROL TECHNICAL STANDARDS".
- 2. ALL EROSION CONTROL MEASURES SHALL BE ADJUSTED TO MEET FIELD CONDITIONS AT THE TIME OF CONSTRUCTION AND SHALL BE INSTALLED PRIOR TO ANY GRADING OR DISTURBANCE OF EXISTING SURFACE MATERIAL ON THE SITE.
- 3. ALL EROSION AND SEDIMENT CONTROL MEASURES WILL BE CHECKED FOR STABILITY AND OPERATION AFTER A RAINFALL OF 0.5 INCHES OR MORE, BUT NO LESS THAN ONCE EVERY WEEK. MAINTENANCE OF ALL EROSION CONTROL STRUCTURES SHALL BE PROVIDED TO INSURE INTENDED PURPOSE IS ACCOMPLISHED. REPAIRS AND MAINTENANCE SHALL BE COMPLETED WITHIN 24 HOURS OF INSPECTION. CONTRACTOR SHALL BE RESPONSIBLE FOR CLEANUP AND REMOVAL OF ALL SEDIMENT WHEN LEAVING PROPERTY. EROSION CONTROL MEASURES MUST BE IN WORKING CONDITION AT END OF EACH WORK DAY.
- 4. SILT FENCE SHALL BE INSTALLED IN THE LOCATIONS SHOWN ON THE CONSTRUCTION PLANS. SEDIMENT DEPOSITS WILL BE REMOVED FROM BEHIND THE SILT FENCE WHEN DEPOSITS REACH A DEPTH OF 6 INCHES. THE SILT FENCE WILL BE REPAIRED OR REPLACED AS NECESSARY TO MAINTAIN A BARRIER.
- 5. CRUSHED STONE ENTRANCE SHALL BE MAINTAINED BY TURNING OVER THE STONE OR BY PLACING NEW STONE ONCE THE SURFACE BECOMES CLOGGED WITH SEDIMENT.
- 6. EROSION CONTROL MEASURES SHALL BE MAINTAINED ON A CONTINUING BASIS UNTIL SITE IS FULLY STARILIZED.
- 7. PERIODIC SWEEPING SHALL BE COMPLETED TO MAINTAIN THE OAK LEAF TRAIL FREE OF DUST AND DIRT
- 8. SILT FENCE SHALL BE INSTALLED IN HORSESHOE FASHION AROUND ALL TOPSOIL AND FILL STOCKPILES. NOTIFY CITY OF GLENDALE OF ANY NEW STOCKPILE LOCATIONS.
- 9. CONSTRUCTION SEQUENCE FOR EROSION CONTROL INCLUDES:
- 1. INSTALL STABILIZED CONSTRUCTION ENTRANCE.
- 2. INSTALL SILT FENCE.
- . STRIP TOPSOIL FROM SITE.
- 4. PERFORM ROUGH GRADING.
- 5. INSTALL PAVEMENTS AND RETAINING WALLS.
- 6. INSTALL LANDSCAPING ON COMPLETED SITE WITHIN 7 DAYS OF COMPLETING CONSTRUCTION.
 7. REMOVE EROSION CONTROL MEASURES ONLY WHEN SITE IS FULLY STABILIZED.
- 10. SITE DEWATERING. WATER PUMPED FROM THE SITE SHALL BE TREATED BY SEDIMENT BASINS OR OTHER APPROPRIATE BEST MANAGEMENT PRACTICES SPECIFIED IN THE WDNR "CONSTRUCTION SITE EROSION AND SEDIMENT CONTROL TECHNICAL STANDARDS". WATER SHALL NOT BE DISCHARGED IN A MANNER THAT CAUSES EROSION OF THE SITE, ADJACENT SITES, OR RECEIVING CHANNELS.
- 11. WASTE AND MATERIAL DISPOSAL. ALL WASTE AND UNUSED BUILDING MATERIALS (INCLUDING GARBAGE, DEBRIS, CLEANING WASTES, WASTEWATER, TOXIC MATERIALS, OR HAZARDOUS MATERIALS) SHALL BE PROPERLY DISPOSED AND NOT ALLOWED TO BE CARRIED OFF—SITE BY RUNOFF OR WIND.
- 12. TRACKING. EACH SITE SHALL HAVE GRAVELED ROADS, ACCESS DRIVES AND PARKING AREAS OF SUFFICIENT WIDTH AND LENGTH TO PREVENT SEDIMENT FROM BEING TRACKED ONTO PUBLIC OR PRIVATE ROADWAYS. ANY SEDIMENT REACHING A PUBLIC OR PRIVATE ROAD SHALL BE REMOVED BY STREET CLEANING, TO THE SATISFACTION OF THE CITY, BEFORE THE END OF EACH WORKDAY. FLUSHING MAY NOT BE USED UNLESS SEDIMENT WILL BE CONTROLLED BY A SEDIMENT BASIN OR OTHER APPROPRIATE BEST MANAGEMENT PRACTICE SPECIFIED IN THE WDNR "CONSTRUCTION SITE EROSION AND SEDIMENT CONTROL TECHNICAL STANDARDS". NOTIFY CITY OF GLENDALE FOR CHANGES IN STABILIZED CONSTRUCTION ENTRANCE LOCATION.
- 13. SEDIMENT CLEANUP. ALL OFF-SITE SEDIMENT DEPOSITS OCCURRING AS A RESULT OF A STORM EVENT SHALL BE CLEANED UP BY THE END OF THE NEXT WORK DAY. ALL OTHER OFF-SITE SEDIMENT DEPOSITS OCCURRING AS A RESULT OF CONSTRUCTION ACTIVITIES SHALL BE CLEANED UP BY THE END OF THE THE WORK DAY.
- 14. ALL DISTURBED GROUND LEFT INACTIVE FOR SEVEN OR MORE DAYS SHALL BE STABILIZED BY TEMPORARY OR PERMANENT SEEDING, AND MULCHING SODDING, COVERING WITH TARPS, OR EQUIVALENT BEST MANAGEMENT PRACTICES. IF TEMPORARY SEEDING IS USED, A PERMANENT COVER SHALL ALSO BE REQUIRED AS PART OF THE FINAL SITE STABILIZATION. SEEDING OR SODDING SHALL BE REQUIRED AS PART OF THE FINAL SITE STABILIZATION.
- 15. PERMANENT SEEDING SHALL BE ESTABLISHED NO LATER THAN SEPTEMBER 15TH. IF PERMANENT SEEDING IS NOT ESTABLISHED, TEMPORARY SEEDING SHALL BE ESTABLISHED NO LATER THAN OCTOBER 15TH. ALL SEEDED AREAS MUST BE MULCHED AT A RATE OF 1.5 TO 2 TONS PER ACRE AND ANCHORED BY EITHER CRIMPING OR BY APPLYING A TACKIFIER.
- 16. PERMANENT SEED MIX SHALL BE WISDOT SEED MIX NO. 40 AT 7 POUNDS PER 1000 SQUARE FEET.
- 17. 1USE ANNUAL RYE SEED MIX AT 100 POUNDS PER ACRE AS A TEMPORARY SEED MIX. PERMANENT SEEDING SHALL FOLLOW WITHIN ONE YEAR. IF TEMPORARY SEEDING IS NOT ESTABLISHED BY OCTOBER 15TH, USE CLASS I TYPE B MATTING ON ALL SLOPES 4:1 OR STEEPER.
- 18. SOIL OR DIRT STORAGE PILES SHALL BE LOCATED A MINIMUM OF TWENTY—FIVE FEET FROM ANY DOWNSLOPE ROAD, LAKE, STREAM, WETLAND, OR DRAINAGE CHANNEL. STRAW BALE OR FILTER FABRIC FENCES SHALL BE PLACED ON THE DOWN SLOPE SIDE OF THE PILE. IF REMAINING FOR MORE THAN THIRTY DAYS. PILES SHALL BE STABILIZED BY MULCHING, VEGETATIVE COVER, TARPS, OR OTHER MEANS.
- 19. WHEN THE DISTURBED AREA HAS BEEN STABILIZED BY PERMANENT VEGETATION OR OTHER MEANS, TEMPORARY BEST MANAGEMENT PRACTICES SUCH AS FILTER FABRIC FENCES, STRAW BALES, SEDIMENT AND SEDIMENT TRAPS SHALL BE REMOVED.
- 20. NOTIFY THE CITY WITHIN TWO WORKING DAYS OF COMMENCING ANY LAND DEVELOPMENT OR LAND DISTURBING ACTIVITY.
- 21. NOTIFY THE CITY OF COMPLETION OF ANY BEST MANAGEMENT PRACTICES WITHIN THE NEXT WORKING DAY AFTER THEIR INSTALLATION.
- 22. OBTAIN PERMISSION IN WRITING FROM THE CITY OF GLENDALE ENGINEERING DEPARTMENT PRIOR TO MODIFYING THE EROSION CONTROL PLAN. NOTIFY WDNR AT LEAST FIVE WORKING DAYS PRIOR TO IMPLEMENTING CHANGES TO THE EROSION CONTROL PLAN.
- 23. REPAIR ANY SILTATION OR EROSION DAMAGE TO ADJOINING SURFACES AND DRAINAGE WAYS RESULTING FROM LAND DEVELOPMENT OR LAND DISTURBING ACTIVITIES.
- 24. KEEP A COPY OF THE EROSION CONTROL PLAN ON SITE. INTERSECTING DIRECTIONS.
- 25. SHORT-TERM DURATION EROSION MATTING SHALL BE INSTALLED ON ALL SLOPES 4:1 OR STEEPER.

NOTICE: In accordance with Wisconsin statute 182.0175, damage to transmission facilities, excavator shall be solely responsible to provide advance notice to the designated "ONE CALL SYSTEM" not less than three working days prior to commencement of any excavation required to perform work contained on this drawing, and further, excavator shall comply with all other requirements of this statute relative to excavator's work.


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GENERAL NOTES

- THE BASE SURVEY WAS PREPARED BY GRAEF IN JULY 2015. ALL UNDERGROUND UTILITIES AND STRUCTURES HAVE BEEN SHOWN TO A REASONABLE DEGREE OF ACCURACY AND IT SHALL BE THE CONTRACTOR'S RESPONSIBILITY TO VERIFY THEIR EXACT LOCATION AND TO AVOID DAMAGE THERETO.
- 2. REFER TO SHEET C100 FOR BENCHMARKS, DATUM, AND TOPOGRAPHIC ELEMENTS.
- 3. CONTRACTOR SHALL VERIFY LOCATION OF PROPOSED WORK AND OAK LEAF TRAIL CONSTRUCTION AND REPORT ANY DISCREPANCIES TO THE ENGINEER PRIOR TO COMMENCING WORK
- 4. CONTRACTOR ACCESS SHALL BE FROM THE JOHNSON CONTROLS PARKING LOT. THE OWNER IS REQUESTING AN ALTERNATE ACCESS FROM THE OAK LEAF TRAIL, WHICH WILL BE CONFIRMED AT A LATER DATE.

LEGEND

— EXISTING FENCE TO REMAIN

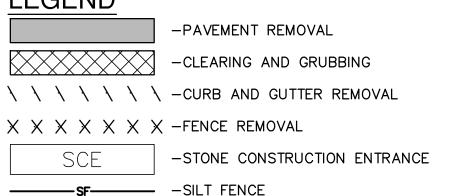

-TEMPORARY DITCH CHECKS

One Honey Creek Corporate Center 125 South 84th Street, Suite 401 Milwaukee, WI 53214-1469 414 / 259 1500 414 / 259 0037 fax

www.graef-usa.com

GRAEF

CONSULTANTS:

PROJECT TITLE:

EXISTING PERMEABLE PAVER PARKING LOT (CONTRACTOR TO USE EXTREME CAUTION TO AVOID DAMAGE AND SEDIMENT TRACKING)

PROJE

— REMOVE EXISTING FENCE.

JOHNSON CONTROLS, INC

SCALE: 1

SALVAGE FOR REUSE AS

SHOWN ON SHEET C300

N: 330,225.5990

E: 598,743.1060

- EXISTING LIGHT POLE

TO REMAIN

REMOVE VERTICAL
CURB AND GUTTER

5757 N GREEN BAY AVE GLENDALE, WISCONSIN

OAK LEAF TRAIL CONNECTOR

IS

NO. DATE REVISIONS

- 2. CONTRACTOR IS RESPONSIBLE FOR COMPLIANCE WITH LOCAL ORDINANCES FOR DUST CONTROL.
- 3. CONTRACTOR SHALL REPLACE/REPAIR ANY ITEMS THAT IS DAMAGED DURING CONSTRUCTION AND NOTED TO REMAIN. ALL REPAIRS OR REPLACEMENTS WILL BE AT THE COST OF THE CONTRACTOR AND TO THE SATISFACTION OF THE OWNER.
- 4. CONTRACTOR SHALL PROTECT CONCRETE CURB AND GUTTER SCHEDULED TO REMAIN OUTSIDE OF CONCRETE APRON. ANY CONCRETE CURB AND GUTTER DAMAGED SHALL BE REPLACED TO THE SATISFACTION OF THE OWNER.
- 5. CONTRACTOR SHALL SAWCUT EXISTING PAVEMENT AS INDICATED ON THE CONSTRUCTION PLANS.

PROJECT INFORMATION:

PROJECT NUMBER: 20151011.00

DATE: 9/24/15
DRAWN BY: AGT

CHECKED BY: PJK
APPROVED BY: JMH

SCALE: AS SHOWN

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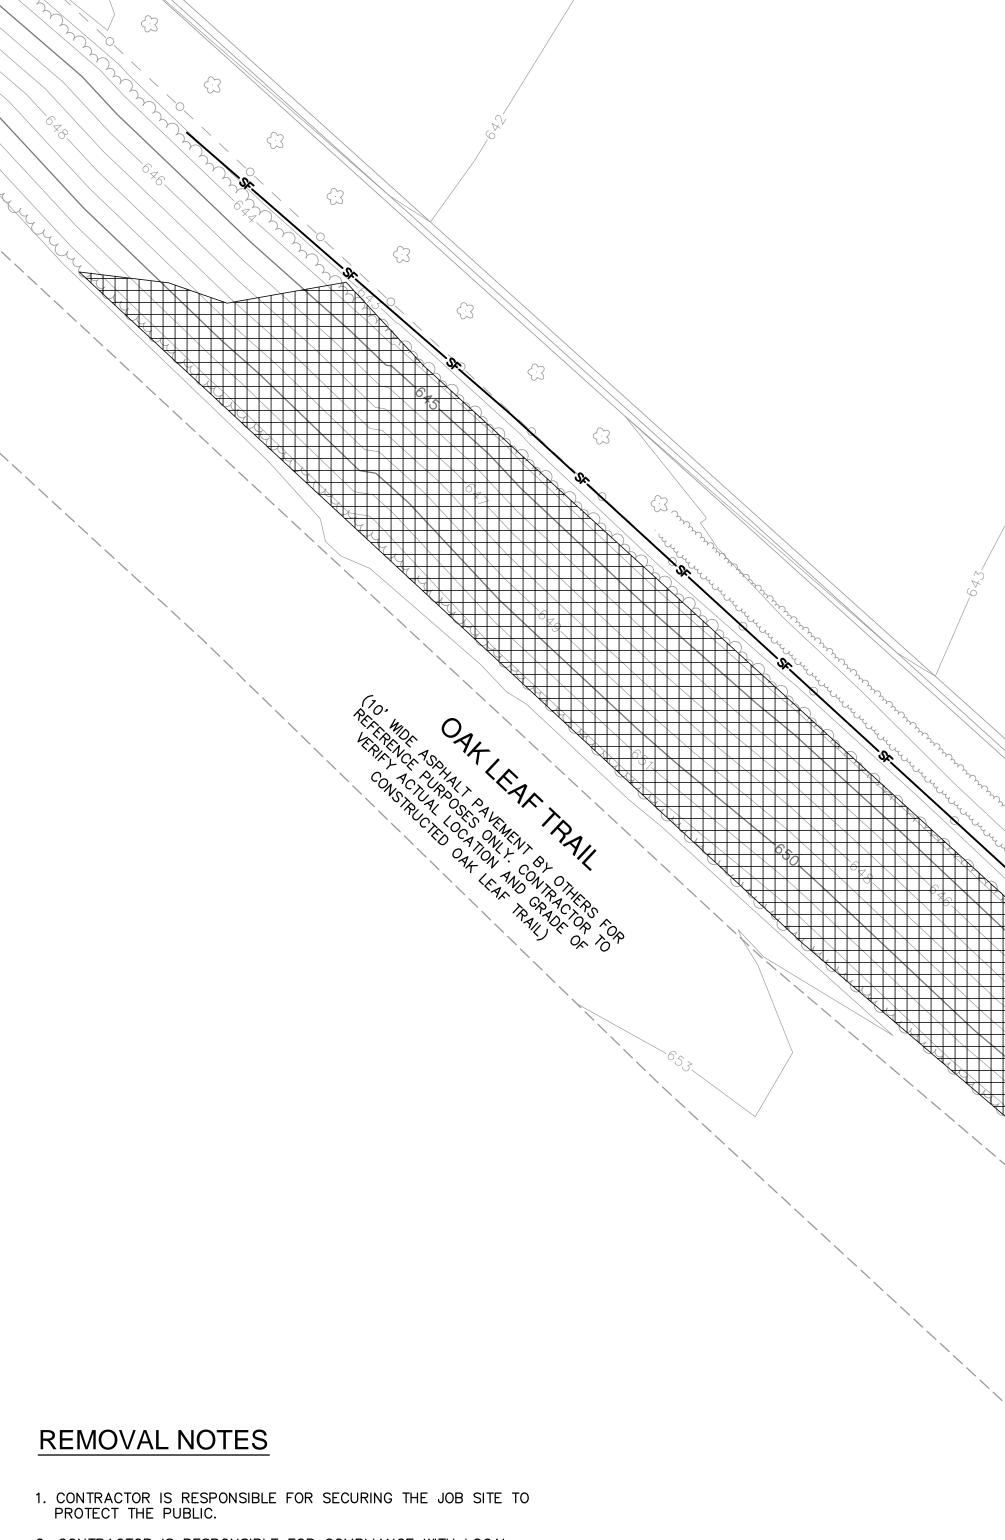
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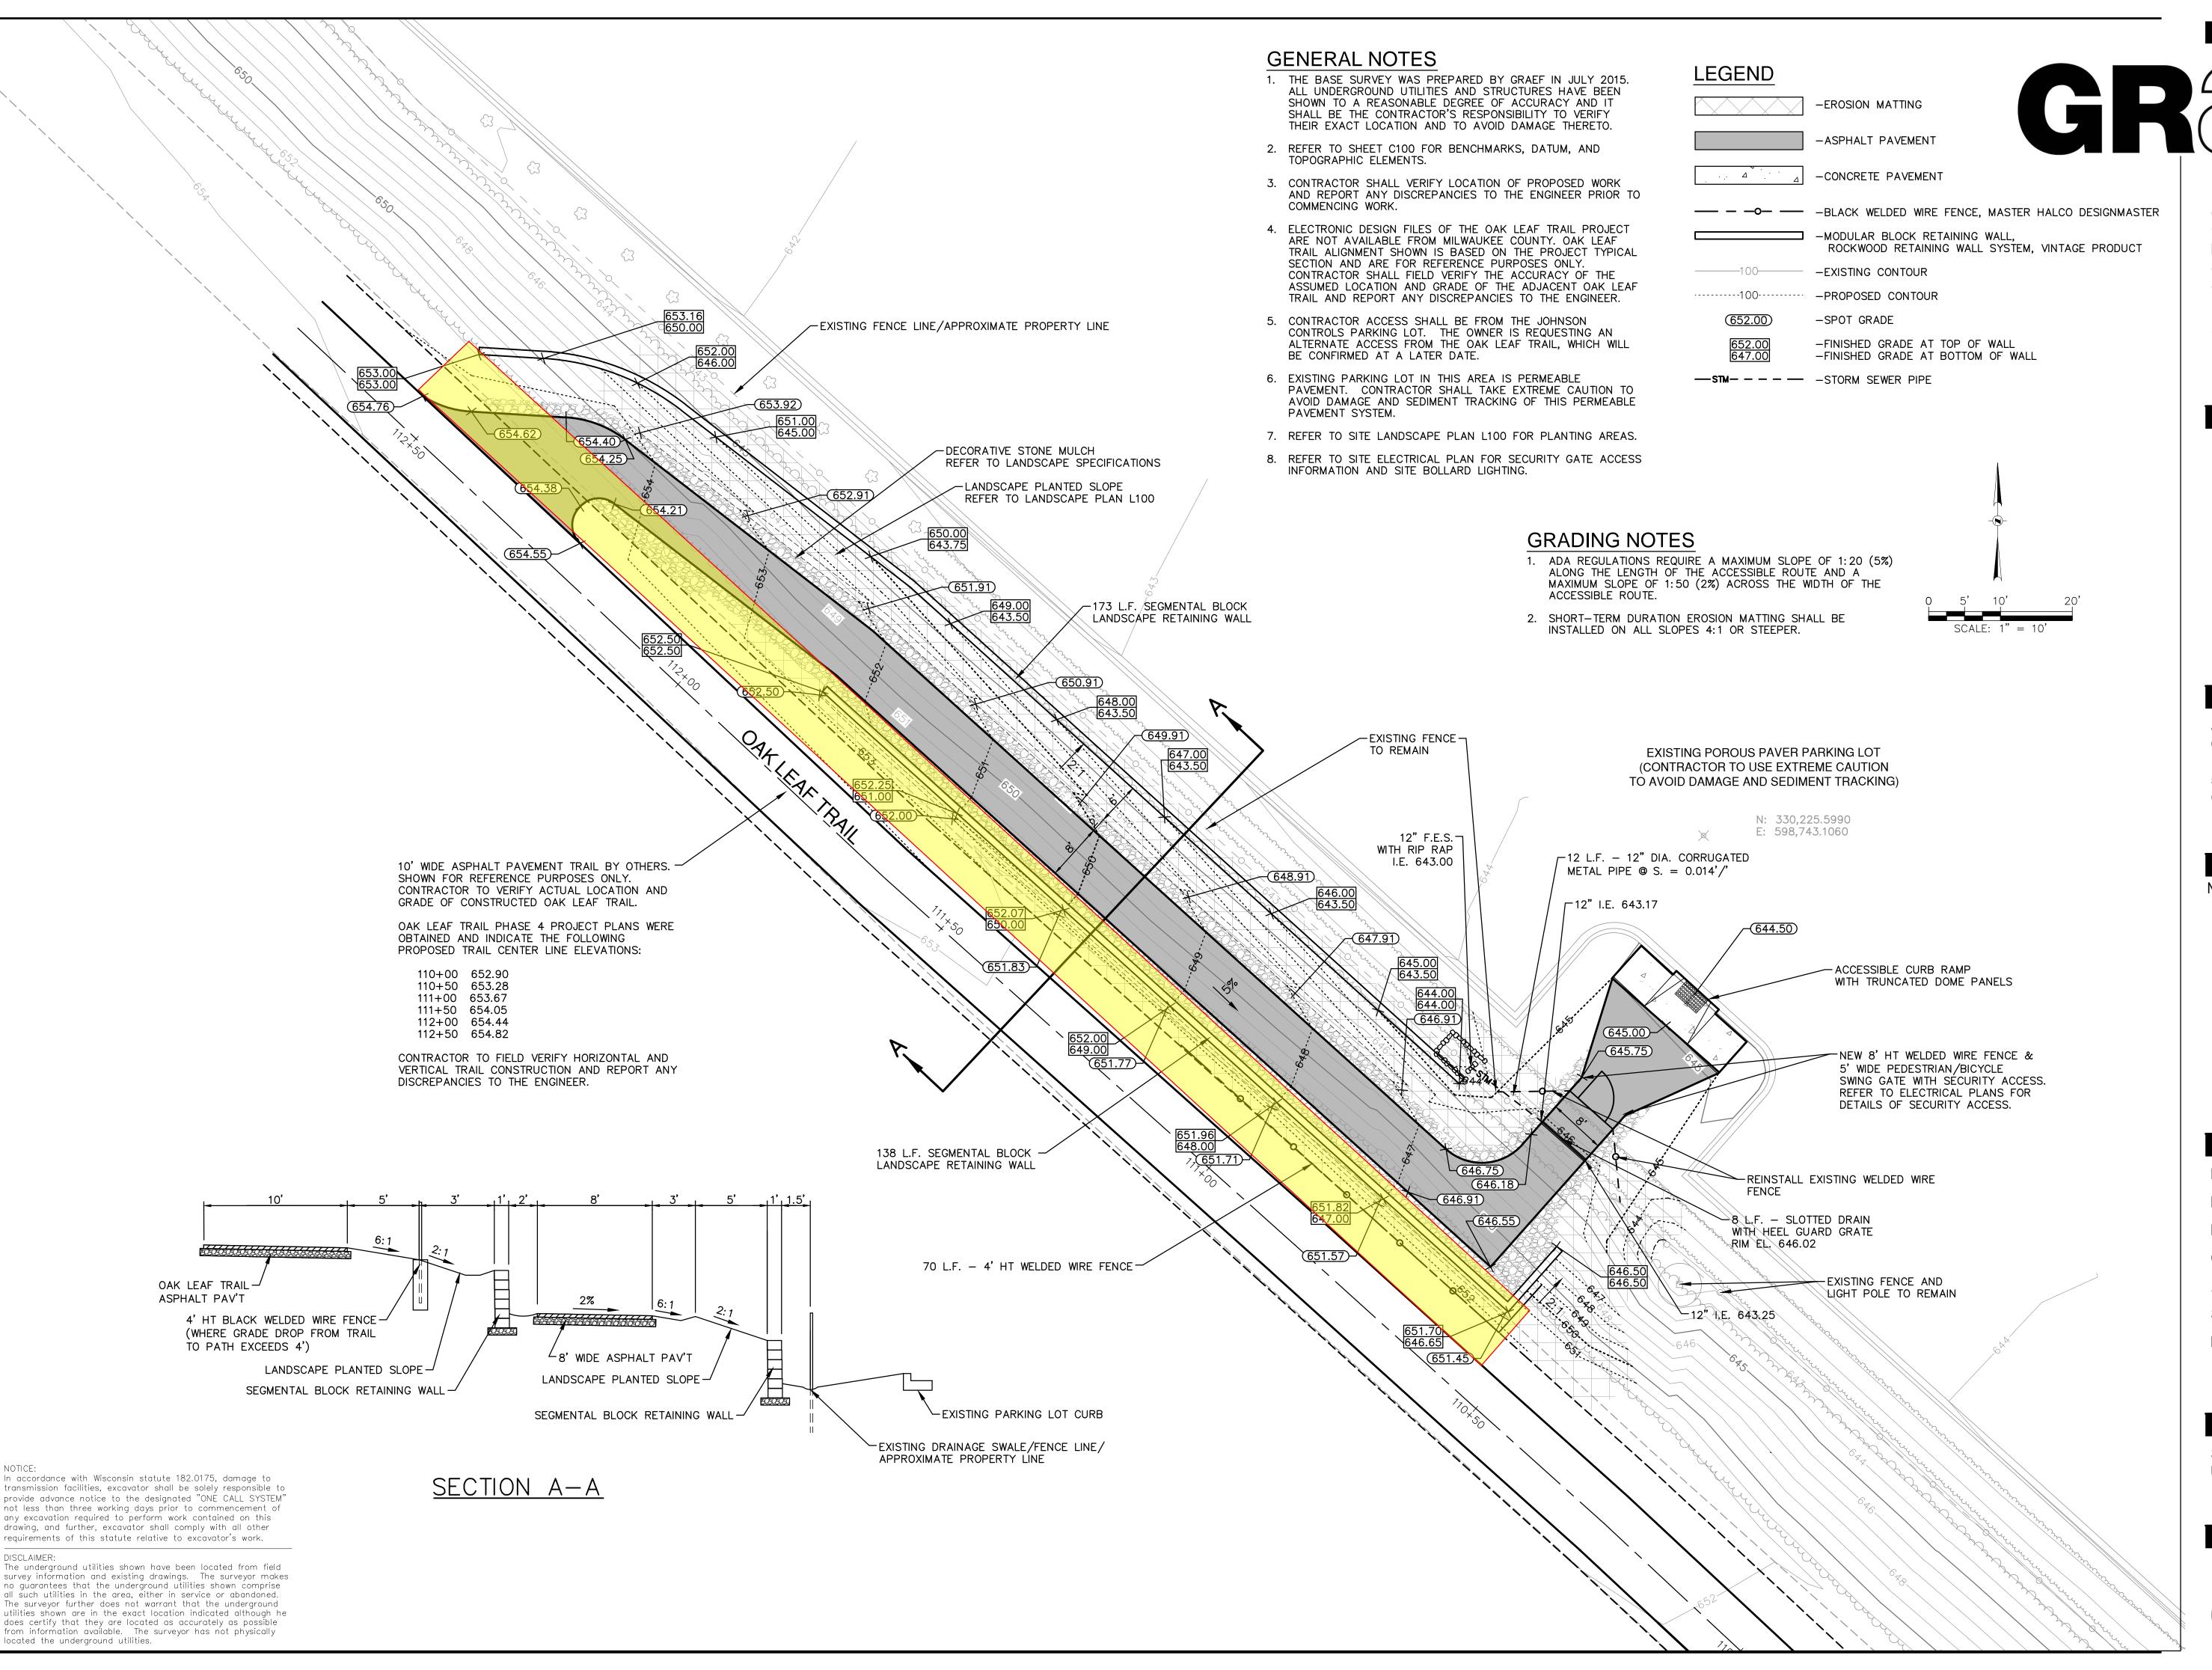
SITE DEMOLITION AND EROSION CONTROL PLAN

SHEET NUMBER:

OHEET NOWE

C200





GREF

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JOHNSON CONTROLS, INC OAK LEAF TRAIL CONNECTOR

5757 N GREEN BAY AVE GLENDALE, WISCONSIN

NO. DATE REVISIONS BY

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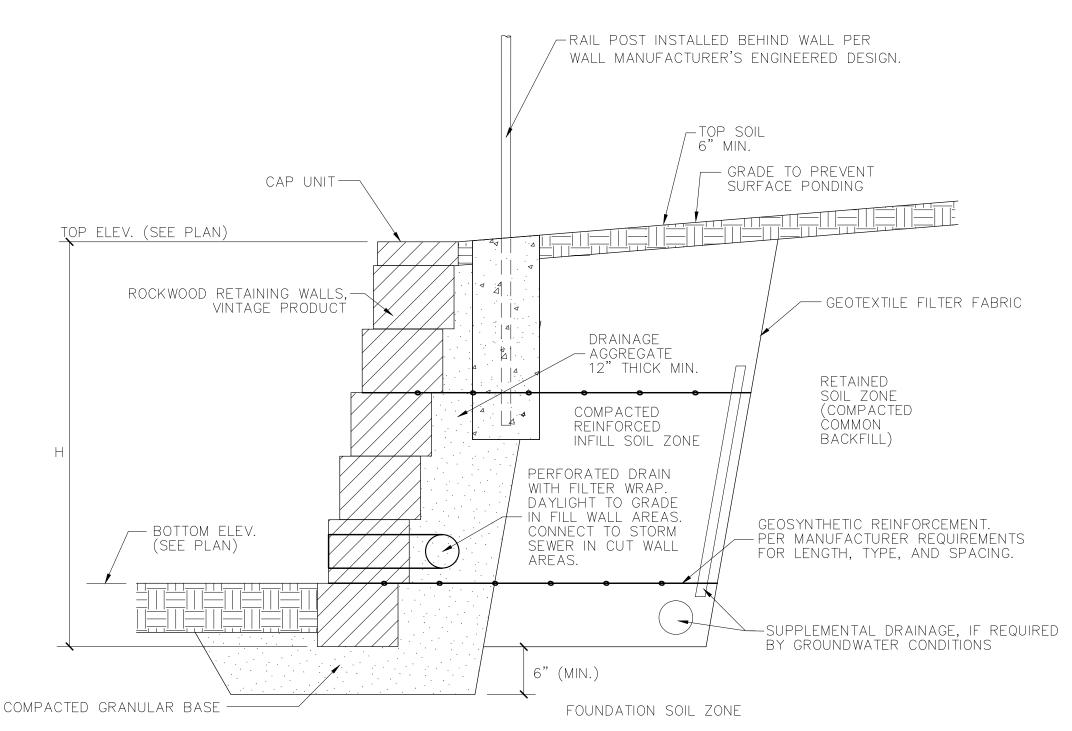
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SHEET TITLE:

SITE LAYOUT, GRADING, AND UTILITY PLAN

SHEET NUMBER:

C300




TYPICAL SEGMENTAL BLOCK RETAINING WALL SECTION


RETAINING WALL NOTES

THE CONTRACTOR SHALL PROVIDE COMPLETE DESIGN, DRAWINGS, DETAILS, SPECIFICATIONS AND SHOP DRAWINGS FOR THE INTERLOCKING BLOCK RETAINING WALLS AND ADJACENT RAILING IN ACCORDANCE WITH THE SPECIFICATIONS. MANUFACTURER SHOP DRAWINGS SHALL SPECIFY THE BLOCK AND GRID MATERIALS USED IN THE DESIGN. MANUFACTURED SHOP DRAWINGS SHALL BE USED FOR THE DETAILED INSPECTION UPON RETAINING WALL AND RELATED MATERIAL DELIVERY PRIOR TO CONSTRUCTION. THE RETAINING WALL MANUFACTURER REPRESENTATIVE SHALL PROVIDE TECHNICAL ASSISTANCE TO THE CONTRACTOR DURING CONSTRUCTION. A GLOBAL STABILITY REVIEW OF THE EXISTING SOILS SHALL BE CONDUCTED PRIOR TO CONSTRUCTION TO ENSURE THAT THE ALLOWABLE BEARING CAPACITY OF THE FOUNDATION SOILS EXCEED THE DESIGN REQUIREMENTS. THE COST OF PROVIDING THESE ITEMS SHALL BE INCLUDED IN THE BID. A GEOTECHNICAL INVESTIGATION OF THIS AREA HAS NOT BEEN CONDUCTED. IT SHALL BE THE RESPONSIBILITY OF THE CONTRACTOR TO PROVIDE AND PAY FOR A GEOTECHNICAL INVESTIGATION AND THE COST SHALL BE INCLUDED IN THEIR BID.

ELEVATIONS AND DETAILS SHOWN ON THESE DRAWINGS ARE INTENDED TO INDICATE WALL LOCATIONS, LENGTHS, HEIGHTS AND DETAILS COMMON TO ALL WALL SYSTEMS.

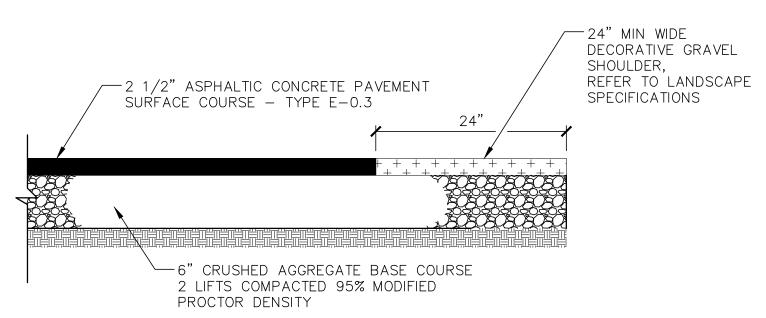

TYPICAL ASPHALT PAVING SECTION FOR BIKE PATH/SIDEWALK N.T.S.

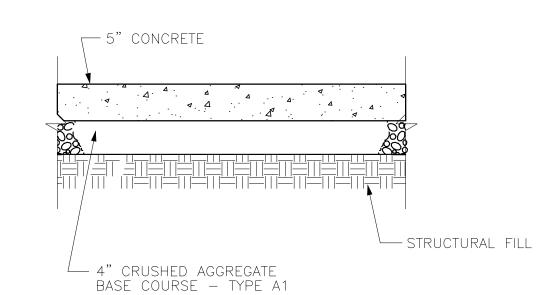

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The underground utilities shown have been located from field


from information available. The surveyor has not physically

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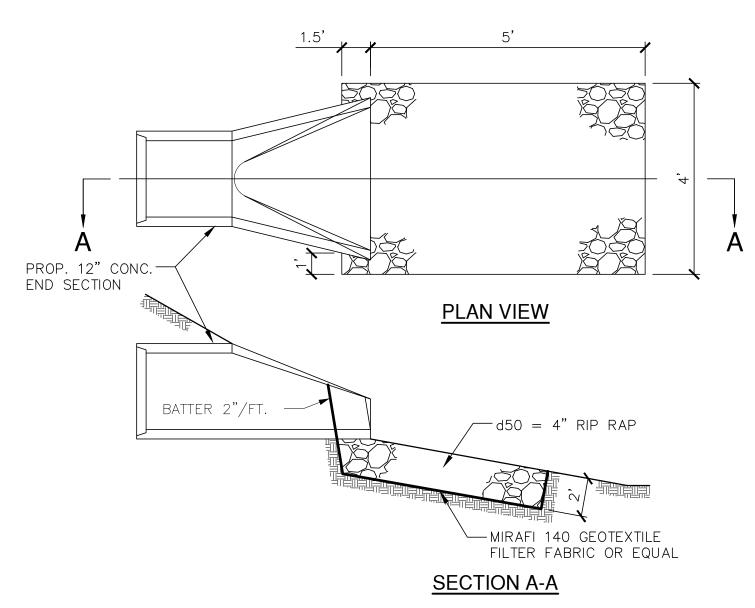
any excavation required to perform work contained on this drawing, and further, excavator shall comply with all other

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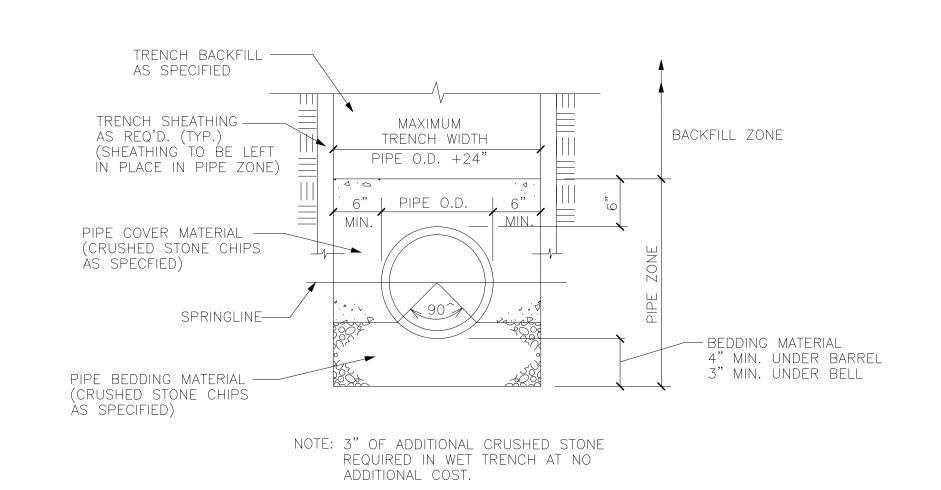
CONCRETE PAVEMENT SECTION N.T.S.




CURB AND SIDEWALK RAMP WHERE PEDESTRIANS CAN CROSS

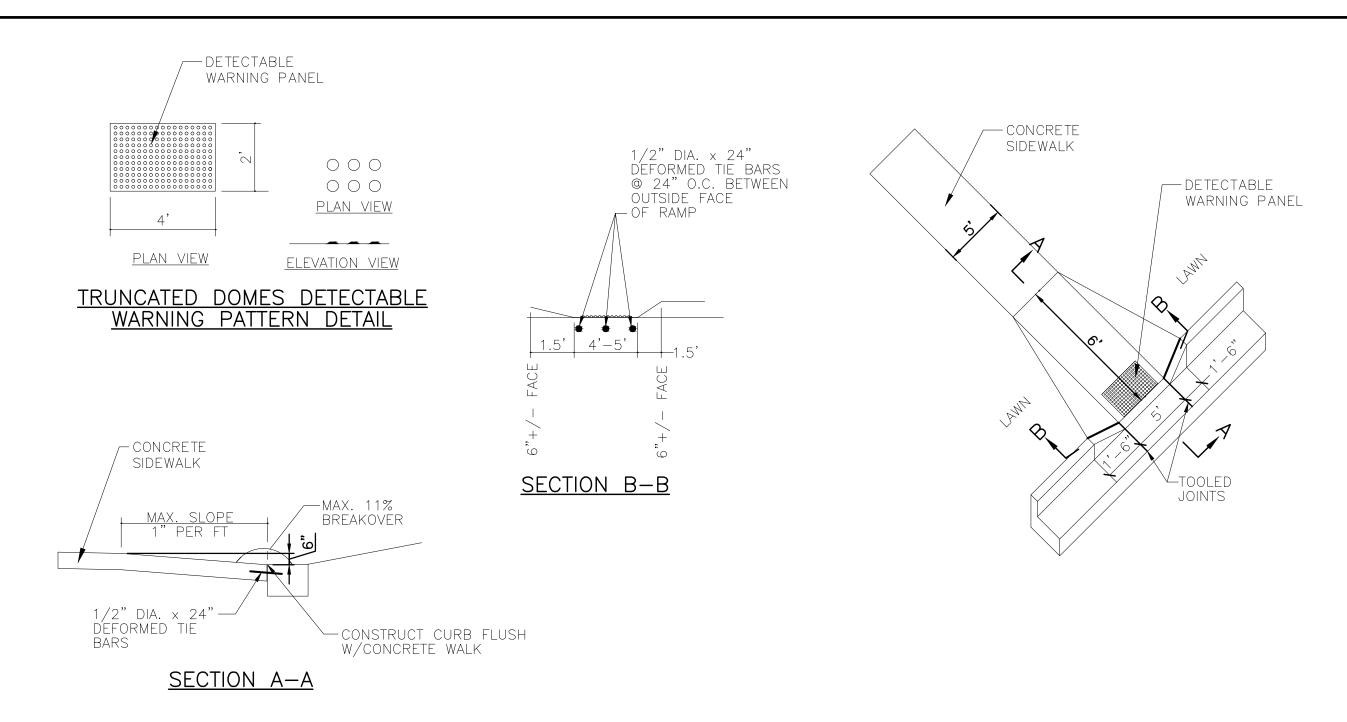


PROPOSED RIP RAP AT 12" STORM SEWER OUTFALL N.T.S.




CLASS "C" BEDDING DETAIL FOR STORM SEWER

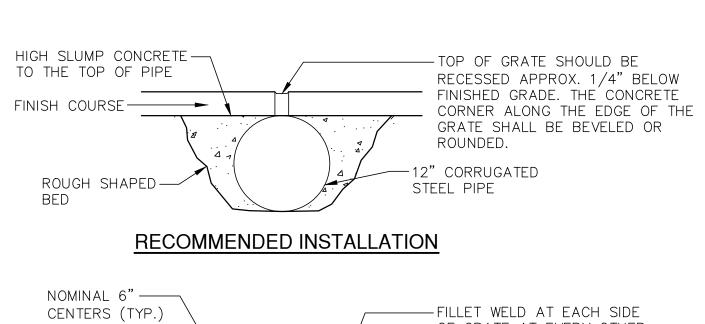


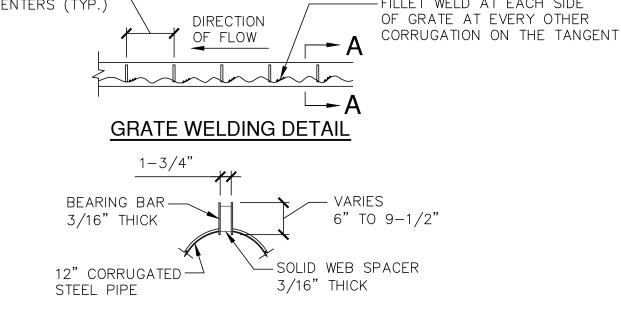

SECTION A-A PARALLEL SIDE GRATE DETAIL

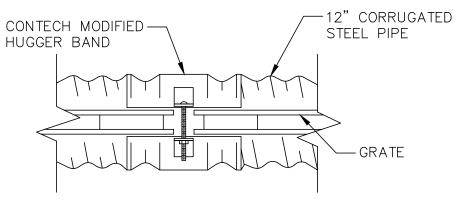

PIPE END CONNECTION DETAIL **TOP VIEW**

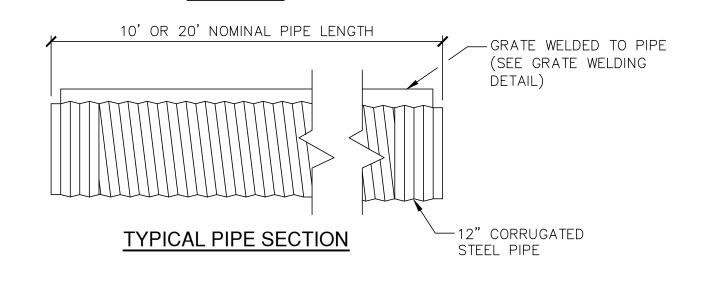

NOTES: SLOTTED DRAIN SHALL BE CONTECH OR EQUAL AND SHALL BE INSTALLED AS PER MANUFACTURER'S RECOMMENDATIONS.

> GRATE SHALL INCLUDE EXPANDED WIRE MESH HEEL GUARD.

SLOTTED DRAIN DETAIL

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5757 N GREEN BAY AVE GLENDALE, WISCONSIN

GRAEF

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CONSULTANTS:

125 South 84th Street, Suite 401

Milwaukee, WI 53214-1469

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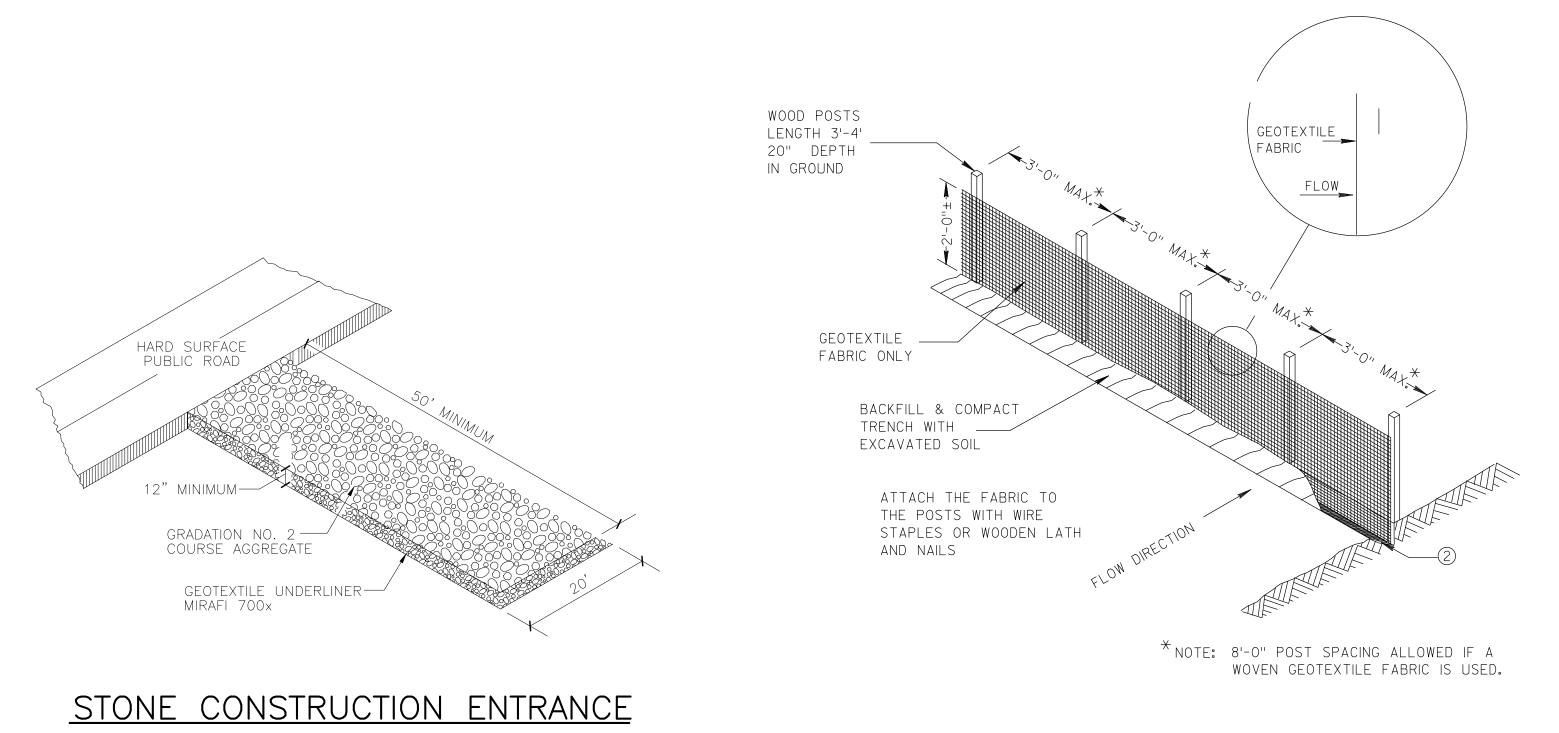
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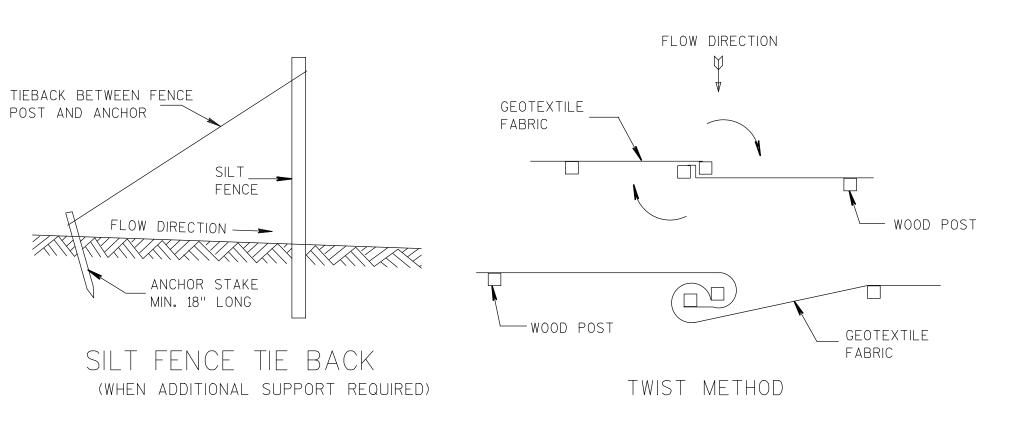
DETAILS

SHEET NUMBER:





JOINING TWO LENGTHS OF SILT FENCE



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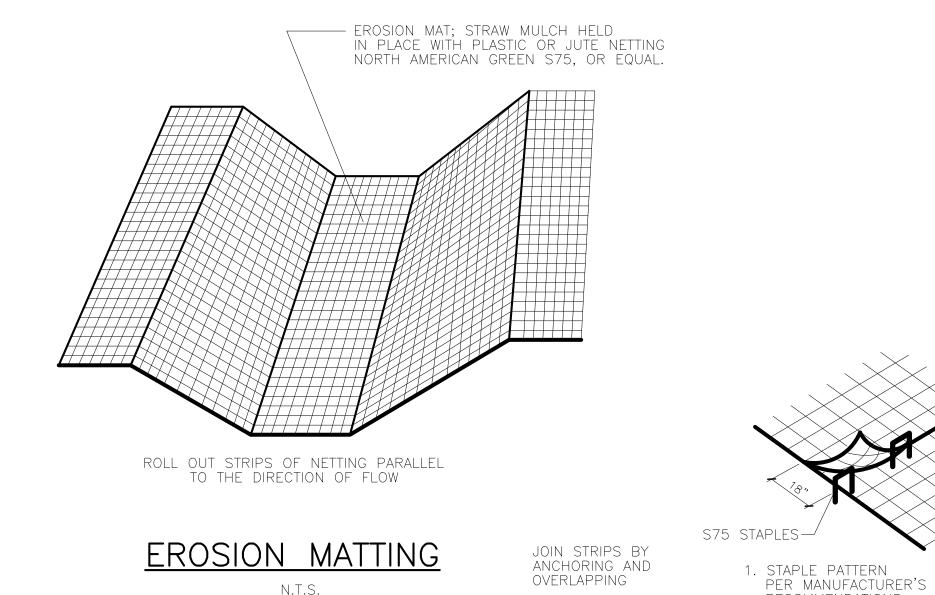
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CONSULTANTS:


SILT FENCE

N.T.S.

RECOMMENDATIONS



N.T.S.

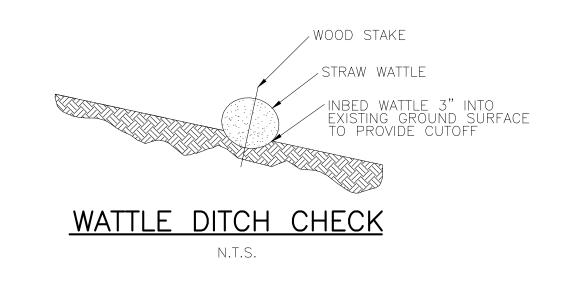

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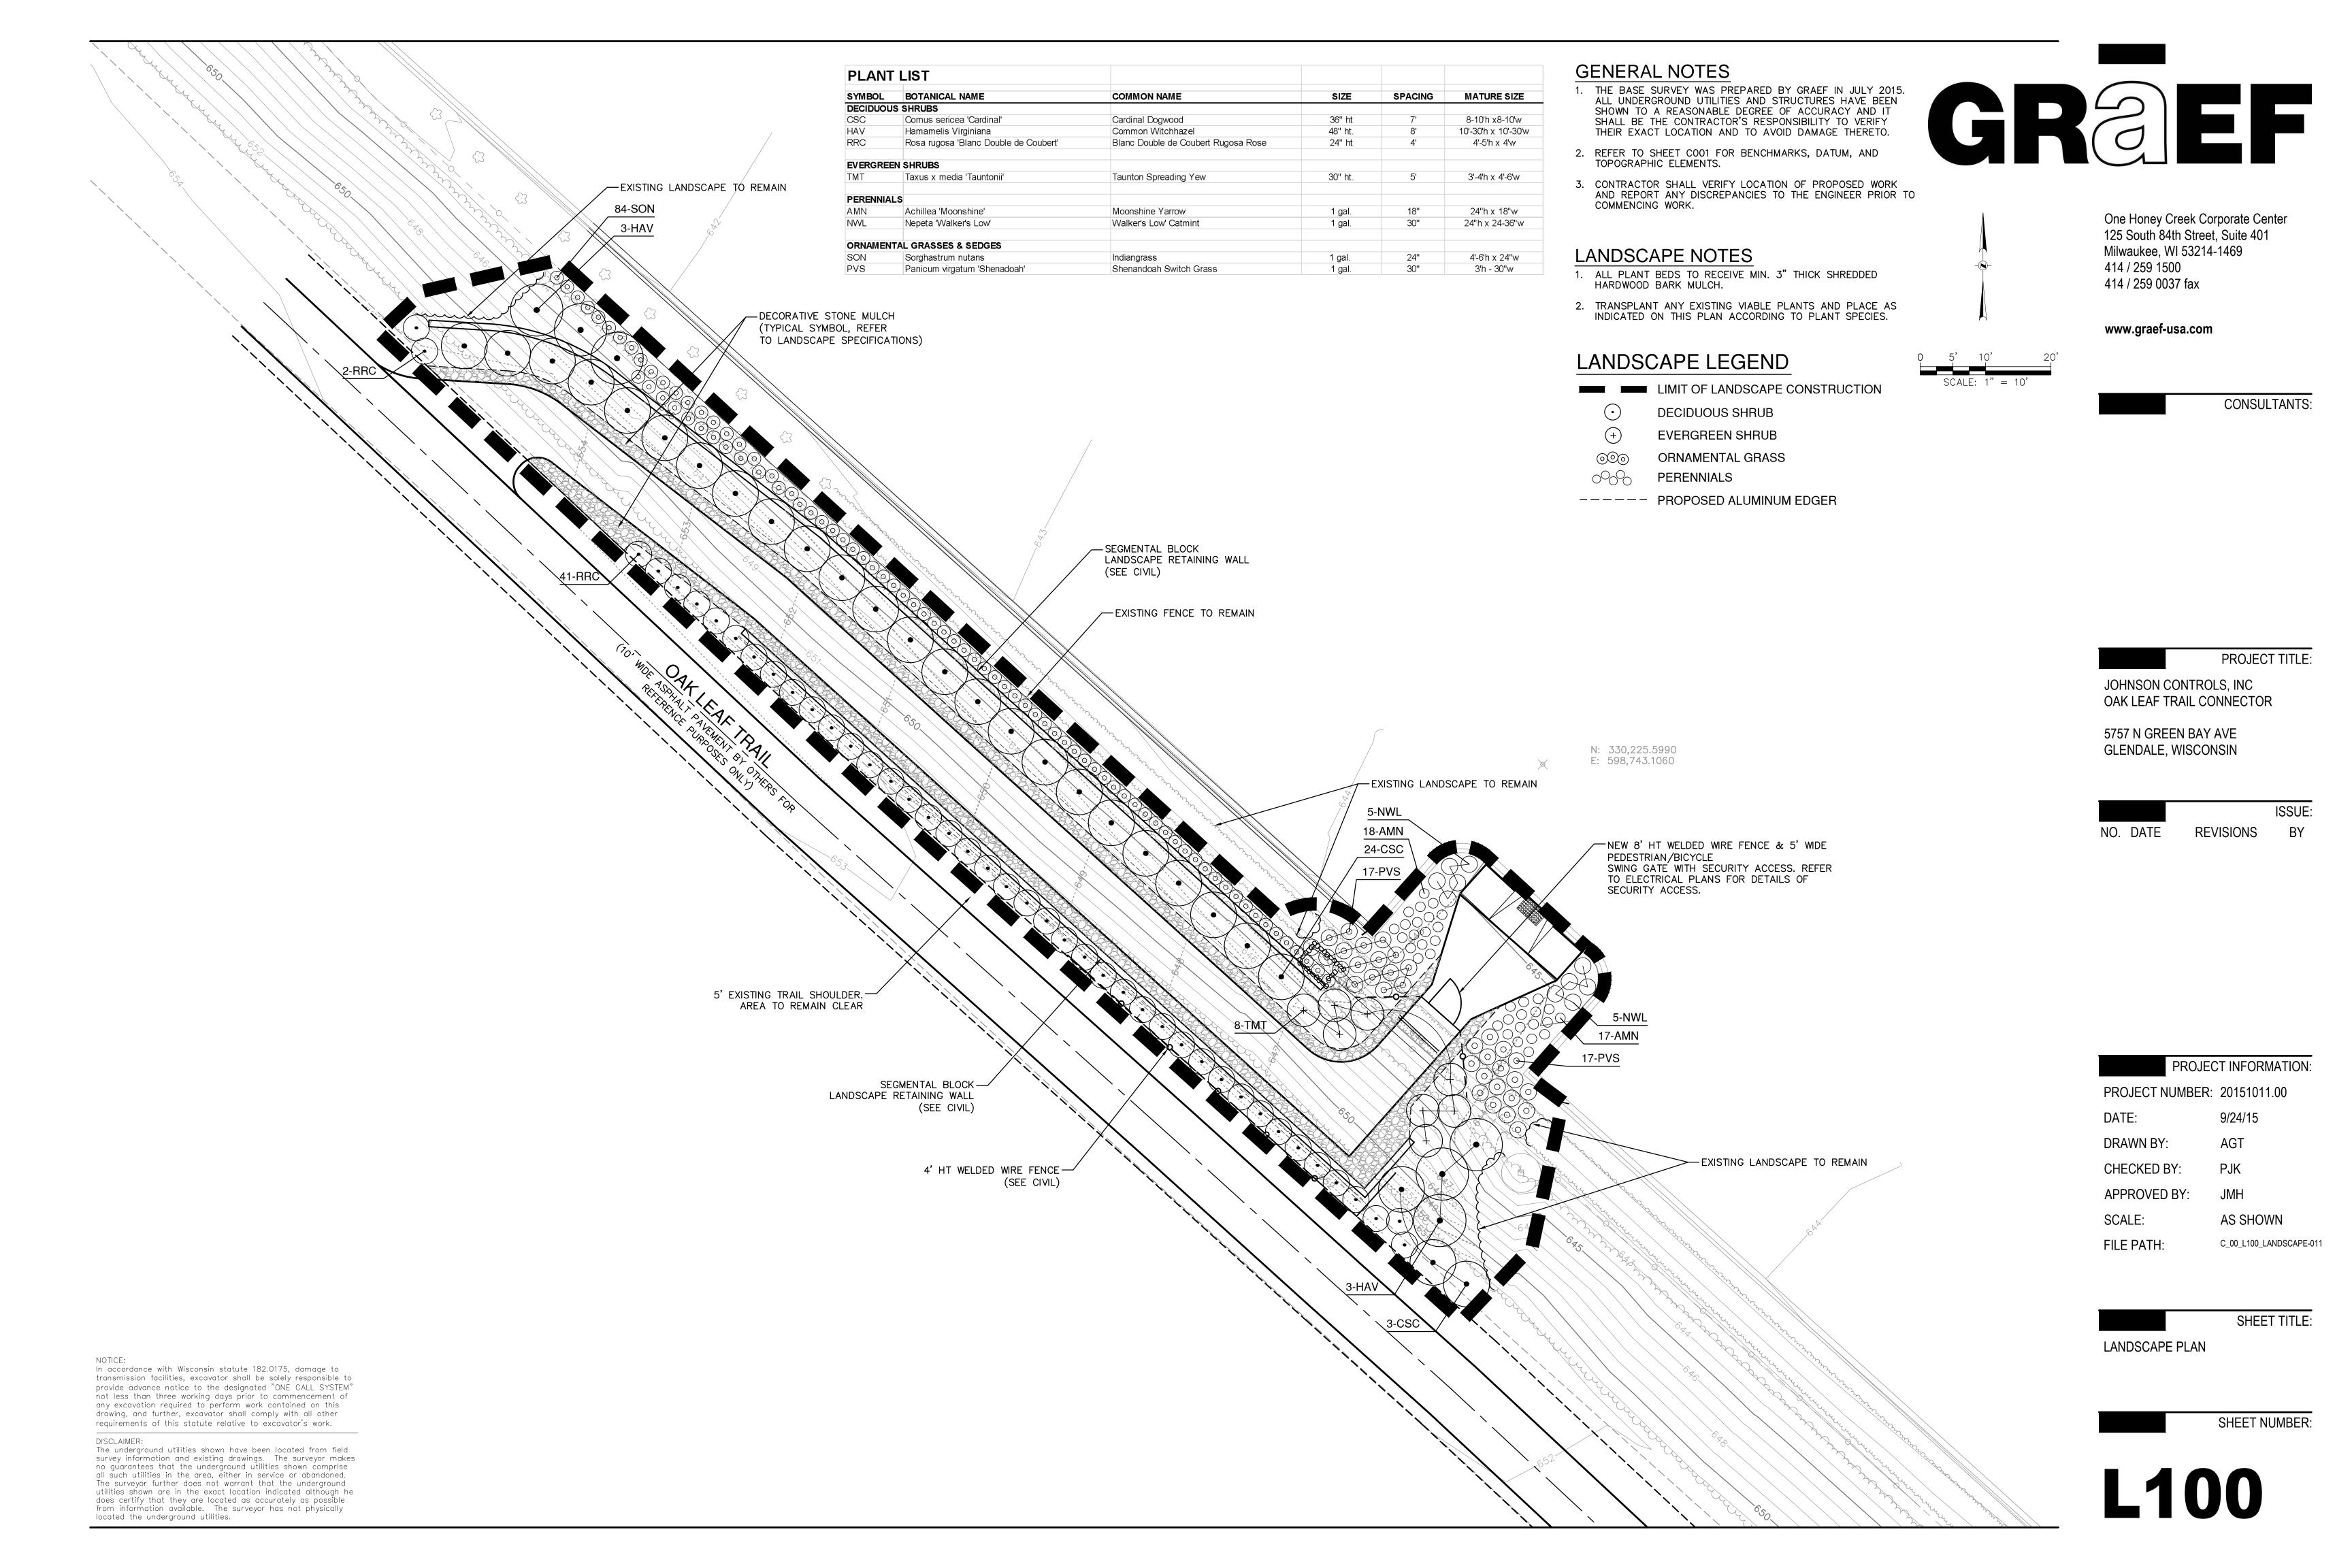
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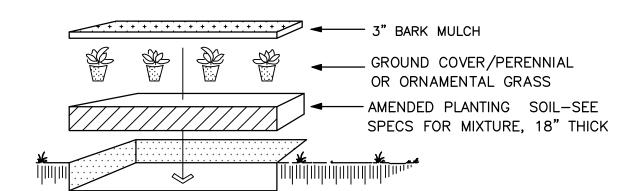
SHEET NUMBER:

C901

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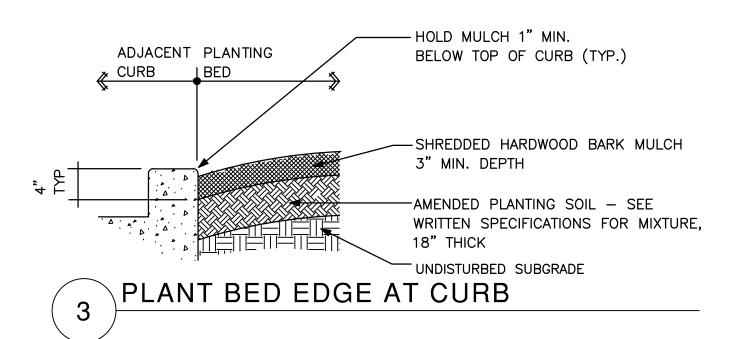


-LANDSCAPE CONTRACTOR SHALL AMEND TOPSOIL FOR PLANT BED AREAS AS DESCRIBED IN WRITTEN SPECIFICATIONS. -LAYOUT PLANT MATERIAL AT SPACING AS SHOWN PER PLANT

MATERIALS SCHEDULE -HAND BROADCAST UNIFORM 3" HARDWOOD MULCH THROUGHOUT GROUNDCOVER / PERENNIAL / ORNAMENTAL GRASS BED -FLOOD IMMEDIATELY & WATER FREQUENTLY PER WRITTEN

SPECIFICATIONS -PLANT SIZES SPECIFIED ARE MINIMUM ACCEPTABLE

GROUND COVER / ORNAMENTAL GRASS / PERENNIAL PLANTING DETAIL



-EXCAVATE PLANTING PIT TWICE THE DIAMETER OF BALL & EQUAL IN

-LOOSEN SUBSOIL W/PICK TO ENSURE POROSITY


-PLACE PLANTING SOIL IN PLANTING PIT & FOOT TAMP. -SELECT BEST VIEWING ANGLE, LIFT STOCK BY BALL & PLACE IN PLANTING PIT.

-UNWRAP TOP HALF OF ROOT BALL. -BACKFILL TO FINISHED GRADE WITH AMENDED PLANTING MIX & TAMP -FORM 3" SAUCER TO ENCIRCLE STOCK & FILL WITH 3" SHREDDED


BARK MULCH. -WATER IMMEDIATELY & FREQUENTLY AS DESCRIBED IN WRITTEN

ACCEPTABLE

SPECIFICATION -PLANT SIZES SPECIFIED ARE MINIMUM

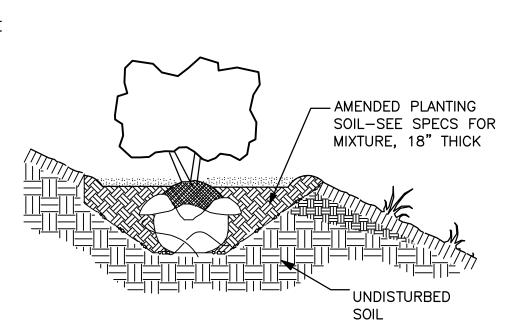

SHRUB PLANTING ON SLOPE DETAIL

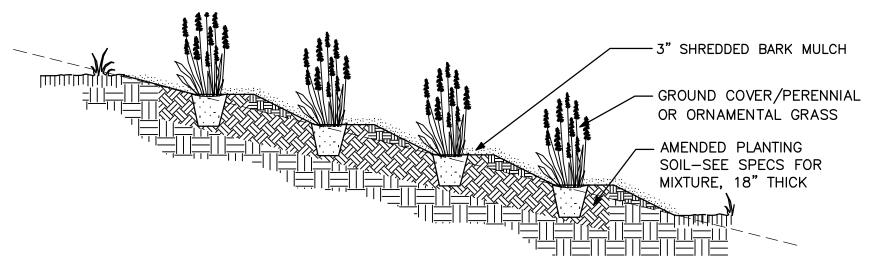

-LANDSCAPE CONTRACTOR SHALL AMEND TOPSOIL FOR PLANT BED AREAS AS DESCRIBED IN WRITTEN SPECIFICATIONS. -LAYOUT PLANT MATERIAL AT SPACING AS SHOWN PER PLANT MATERIALS SCHEDULE.

-HAND BROADCAST UNIFORM 3" HARDWOOD MULCH THROUGHOUT GROUNDCOVER / PERENNIAL / ORNAMENTAL GRASS BED. -FLOOD IMMEDIATELY & WATER FREQUENTLY PER WRITTEN SPECIFICATIONS. -PLANT SIZES SPECIFIED ARE MINIMUM ACCEPTABLE.

GROUND COVER / ORNAMENTAL GRASS PERENNIAL PLANTING ON SLOPE DETAIL

LANDSCAPING AND PLANTING NOTES:

1. BECOME AWARE OF ALL RELATED EXISTING AND PROPOSED CONDITIONS, UTILITIES, PIPES AND STRUCTURES, ETC. PRIOR TO BIDDING AND CONSTRUCTION.

2. INSPECT THE SITE PRIOR TO COMMENCING WORK. DOCUMENT IN WRITING AND PHOTOGRAPH ALL EXISTING CONDITIONS WITHIN, AND IN AREAS ADJACENT TO, THE LIMITS OF CONSTRUCTION. DIGITAL COPIES OF PHOTOGRAPHS SHALL BE PROVIDED TO THE LANDSCAPE ARCHITECT. THE LANDSCAPE CONTRACTOR SHALL BE HELD RESPONSIBLE FOR ANY DAMAGES NOT DOCUMENTED IN THE SUBMITTAL PRIOR TO COMMENCEMENT OF DEMOLITION ACTIVITIES.

3. CONTACT ALL UTILITY COMPANIES FOR FIELD LOCATION OF ALL PUBLIC UNDERGROUND UTILITY LINES, INCLUDING DEPTHS OF SAID, WITHIN THE LIMITS OF CONSTRUCTION. THE LANDSCAPE CONTRACTOR SHALL BE RESPONSIBLE FOR CONTACTING THE OWNER'S REPRESENTATIVE FOR FIELD LOCATION OF ALL PRIVATE UTILITIES WITHIN THE LIMITS OF CONSTRUCTION. LANDSCAPE CONTRACTOR SHALL TAKE SOLE RESPONSIBILITY FOR ANY AND ALL COST OR OTHER LIABILITIES INCURRED DUE TO DAMAGE OF SAID UTILITIES/STRUCTURES/ETC.

4. DO NOT WILLFULLY PROCEED WITH CONSTRUCTION AS DESIGNED WHEN IT IS APPARENT THAT UNKNOWN OBSTRUCTIONS AND/OR GRADE DIFFERENCES EXIST THAT MAY NOT HAVE BEEN KNOWN DURING DESIGN. SUCH CONDITIONS SHALL BE IMMEDIATELY BROUGHT TO THE ATTENTION OF THE OWNER'S REPRESENTATIVE FOR CLARIFICATION. THE LANDSCAPE CONTRACTOR SHALL ASSUME FULL RESPONSIBILITY FOR ALL LIABILITIES, INCLUDING NECESSARY REVISIONS DUE TO FAILURE TO GIVE SUCH NOTIFICATION.

5. COMMENCEMENT OF WORK CONSTITUTES ACCEPTANCE OF SITE CONDITIONS, BOTH SURFACE AND SUBSURFACE. NO EXTRA PAYMENT SHALL ACCRUE BY VIRTUE OF UNKNOWN CONDITIONS FOR DIFFICULTIES IN PERFORMING THE CONTRACTED SCOPE OF WORK.

6. COORDINATE WITH SUBCONTRACTORS AS REQUIRED TO ACCOMPLISH LANDSCAPE WORK, PLANTING WORK, AND RELATED OPERATIONS WITHIN THE CONTRACTED SCOPE.

7. REFER TO GEOTECHNICAL REPORT FOR INFILTRATION AND SOIL TYPES / CONDITIONS.

8. SEE SPECIFICATIONS AND DETAILS FOR PLANTING METHODS, REQUIREMENTS, SOIL TESTING, MATERIALS, EXECUTION AND PLANT PROTECTION, PLANT STAKING METHODS, PLANT PIT DIMENSIONS, BACKFILL AND OTHER RELATED REQUIREMENTS.

9. THE ACCEPTABLE TOLERANCES FOR THIS PROJECT ARE MINIMAL AND SPECIFIC LAYOUT IS REQUIRED AS SHOWN ON THE LAYOUT, PLANTING, AND OTHER PLANS. PLANTS SHALL BE SPACED AS PER PLANS.

10. PLANT NAMES MAY BE ABBREVIATED ON THE DRAWINGS. SEE PLANT LIST FOR SYMBOLS, ABBREVIATIONS, BOTANICAL/COMMON NAMES, SIZES, ESTIMATED QUANTITIES (IF GIVEN) AND OTHER REMARKS.

11. FURNISH ALL PLANT MATERIALS FREE OF PESTS OR PLANT DISEASES. MAINTAIN AND WARRANT ALL PLANT MATERIALS PER THE SPECIFICATIONS FOR ONE COMPLETE GROWING SEASON FOLLOWING INSTALLATION AND OWNER'S ACCEPTANCE. ALL PLANTS SHALL BE SUBJECT TO OWNER'S ACCEPTANCE PRIOR TO INSTALLATION.

12. FINE GRADE, RAKE AND BE RESPONSIBLE FOR POSITIVE DRAINAGE AWAY FROM ALL STRUCTURES AND THROUGHOUT SITE WITHIN THE LIMITS OF CONSTRUCTION, WITH ACCURATELY SET FLOW LINES. NO LOW SPOTS OR PONDING OF SURFACE WATER WILL BE ACCEPTED IN THE FINAL WORK. NO ROCKS OR DEBRIS WILL BE ACCEPTED. FINAL GRADE TOLERANCES ARE +/-0.1 FOOT MAXIMUM.

13. WHERE PROVIDED, AREA TAKEOFFS AND PLANT QUANTITY ESTIMATES ARE FOR INFORMATION ONLY. LANDSCAPE CONTRACTOR IS RESPONSIBLE TO CONDUCT QUANTITY TAKE—OFFS FOR ALL PLANT MATERIALS AND SIZES SHOWN ON PLANS. THE PLANS (PLANT SYMBOLS) TAKE PRECEDENCE IN CASE OF ANY DISCREPANCIES BETWEEN CALLOUTS, THE PLANT LIST, AND THE PLANS.

14. COORDINATE WITH OTHER TRADES THE INSTALLATION OF PLANT MATERIAL WITH INSTALLATION OF ALL ADJACENT PAVEMENTS. DRAINAGE CURB AND RELATED STRUCTURES. DAMAGE CAUSED DURING LANDSCAPE INSTALLATION TO EXISTING CONDITIONS AND IMPROVEMENTS IS THE RESPONSIBILITY OF THE LANDSCAPE CONTRACTOR.

15. UNLESS OTHERWISE INDICATED: SHRUBS. PERENNIALS. AND ORNAMENTAL GRASSES SHALL BE PLACED IN STRAIGHT ROWS. EQUALLY SPACED; AND ALL PLANTING AREAS, INCLUDING PLANTING BEDS, SHALL RECEIVE SOIL AMENDMENTS AS DESCRIBED IN WRITTEN SPECIFICATIONS.

16. "RESTORE" ALL AREAS OF THE SITE, OR ADJACENT AREAS, WHERE DISTURBED.

17. TAKE NECESSARY SCHEDULING AND OTHER PRECAUTIONS TO AVOID WINTER, CLIMATIC, OR OTHER DAMAGE TO PLANTS.

18. ALL PLANT BEDS ARE TO RECEIVE 3" DEEP LAYER OF SHREDDED HARDWOOD BARK MULCH AS DEFINED IN WRITTEN

19. ALL PLANTING BEDS ARE TO BE INSTALLED PER LANDSCAPE DETAILS.

20. PLANT SUBSTITUTIONS WILL NOT BE PERMITTED UNLESS IT CAN BE VERIFIED UNEQUIVOCALLY THAT THE PLANTS ARE NOT AVAILABLE FROM NURSERY SOURCES LOCATED A REASONABLE DISTANCE FROM THE PROJECT SITE. IF THIS SHOULD HAPPEN, ANY PROPOSED PLANT SUBSTITUTION WILL REQUIRE PRIOR REVIEW AND ACCEPTANCE BY THE PROJECT LANDSCAPE ARCHITECT.


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STOCK & FILL WITH 3" SHREDDED BARK MULCH -WATER IMMEDIATELY & FREQUENTLY AS DESCRIBED IN WRITTEN SPECIFICATION

-FORM 3" SAUCER TO ENCIRCLE -PLANT SIZES SPECIFIED ARE MINIMUM ACCEPTABLE



HRUB PLANTING DETAIL

One Honey Creek Corporate Center 125 South 84th Street, Suite 401 Milwaukee, WI 53214-1469 414 / 259 1500 414 / 259 0037 fax

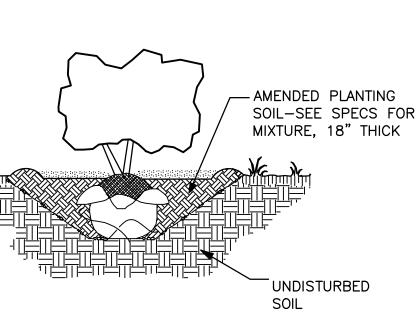www.graef-usa.com

CONSULTANTS:

PROJECT TITLE:

JOHNSON CONTROLS, INC OAK LEAF TRAIL CONNECTOR

5757 N GREEN BAY AVE GLENDALE, WISCONSIN

> ISSUE: NO. DATE REVISIONS

> > PROJECT INFORMATION:

PROJECT NUMBER: 20151011.00

DATE: 9/24/15

DRAWN BY: CHECKED BY: PJK

APPROVED BY:

SCALE: AS SHOWN

FILE PATH: C_00_L900_PLANTING_DETAILS-011

SHEET TITLE:

LANDSCAPE DETAILS AND PLANTING NOTES

SHEET NUMBER:

In accordance with Wisconsin statute 182.0175, damage to transmission facilities, excavator shall be solely responsible to provide advance notice to the designated "ONE CALL SYSTEM" not less than three working days prior to commencement of any excavation required to perform work contained on this drawing, and further, excavator shall comply with all other requirements of this statute relative to excavator's work.

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