2. GENERAL CONTRACTOR SHALL CONSULT WITH STARBUCKS CONSTRUCTION MANAGER TO RESOLVE ANY CHANGES, OMISSIONS, OR PLAN DISCREPANCIES PRIOR TO BIDDING OR CONSTRUCTION.

3. ALL WORK SHALL BE PERFORMED IN STRICT COMPLIANCE WITH LOCAL, COUNTY, STATE, AND FEDERAL CODES AND ORDINANCES.

4. GENERAL CONTRACTOR SHALL VERIFY THE LOCATION OF ALL UTILITIES.

5. GENERAL CONTRACTOR TO VERIFY ALL DIMENSIONS, INCLUDING CLEARANCES REQUIRED BY OTHER TRADES, AND NOTIFY STARBUCKS CONSTRUCTION MANAGER OF ANY DISCREPANCIES PRIOR TO PROCEEDING WITH THE WORK ALL DIMENSIONS ARE TO THE FACE OF THE FINISHED SURFACE UNLESS NOTED OTHERWISE. ALL DIMENSIONS TO BE TAKEN FROM DESIGNATED DATUM POINT. DO NOT SCALE DRAWINGS.

6. GENERAL CONTRACTOR SHALL PATCH AND REPAIR ALL EXISTING WALLS. BECOME DAMAGED DURING THE COURSE OF THE WORK

7. THE GENERAL CONTRACTOR IS RESPONSIBLE FOR OBTAINING PERMITS FOR FIRE PROTECTION, PLUMBING, MECHANICAL, AND ELECTRICAL SYSTEMS PRIOR TO INSTALLATION OF SUCH SYSTEMS.

8. GENERAL CONTRACTOR SHALL RETAIN ONE SET OF THE PLANS TO NOTE AND DOCUMENT ALL CHANGES DURING CONSTRUCTION. THIS SET SHALL BE A PART OF THE GENERAL CONTRACTOR'S "STORE CLOSE-OUT PACKAGE" AS DESCRIBED IN THE CONSTRUCTION MANAGEMENT AGREEMENT.

9. GENERAL CONTRACTOR IS RESPONSIBLE FOR COORDINATING DELIVERY OF MATERIALS FROM STARBUCKS CONTRACTED THIRD PARTY LOGISTICS DISTRIBUTION SERVICES AND VENDOR DIRECT SHIPMLENTS. REFER TO CONSTRUCTION MANAGEMENT AGREEMENT FOR METHODS AND LEAD TIMES.

10. RESPONSIBILITY FOR SUPPLY AND DELIVERY OF MATERIALS AND EQUIPMENT IS IDENTIFIED IN THE DRAWING SCHEDULE SHEETS UNDER THE COLUMN LABELED "RESPONSIBILITY".

11. FOR THE PURPOSE OF THE DOCUMENTS, TO 'INSTALL', SHALL MEAN TO PROVIDE ALL FASTENERS, MISCELLANEOUS HARDWARE, BLOCKING, ELECTRICAL CONNECTIONS, PLUMBING CONNECTIONS, AND OTHER ITEMS REQUIRED FOR A COMPLETE AND OPERATION INSTALLATION, UNLESS OTHERWISE NOTED.

12. ALL ITEM SUBSTITUTIONS MUST BE APPROVED BY THE STARBUCKS DESIGN MANAGER.

13. REFER TO ITEM CUTSHEETS FOR ADDITIONAL INFORMATION.

SITE AND OCCUPANCY

PROJECT DESCRIPTION: Commercial tenant improvements to existing building

BUILDING HEIGHT: 14' - 31/2" BUILDING AREA: 3769 SF BUILDING USE: COMMERCIA ZONING: C9D(A) TYPE OF USE: COFFEE SHOP TYPE OF OCCUPANCY: A-2. ASSEMBLY

113 SF / 30 = 826 SF / 15 = 256 SF / 200 = OCCUPANCY LOAD: RETAIL: BEVERAGE/PREP: WORKROOM/STORAGE: 204 SF / 300 = TOTAL OCCUPANCY =

TOTAL SQUARE FOOTAGE:
TOTAL INERIOR SEATS:
1399 SF
36 INTERIOR SEATS

EXTERIOR SEASONAL SEATING:

EXIT CAPACITY:

EXIT 2: 72° WIDE EXIT 3: 72° WIDE TOTAL EXIT WIDTH PROVIDED: 216 in 61 < 216 THEREFORE COMPLIES

TRAVEL DISTANCE: ALLOWED TRAVEL DISTANCE: 200'-0" ACTUAL TRAVEL DISTANCE: 72'-3"

NUMBER OF EXITS: MIN. NUMBER OF EXITS REQUIRED: 2 NUMBER OF EXITS PROVIDED: 3

SCOPE OF WORK: INTERIOR RENOVATION OF EXISTING COFFEE SHOP

INDEX OF SHEETS

GENERAL

G-0002

G-0010

G-0011

CHICAGO, IL 60661

GENERAL INFORMATION SCOPE OF WORK PLAN DESIGN SPECIFICATIONS DESIGN SPECIFICATIONS

2009 IBC WWISCONSIN COMMERCIAL BUILDING CODE AMENDMENTS - CH. COMM 62.
2009 IBC W/WISCONSIN COMMERCIAL BUILDING CODE AMENDMENTS - CH. COMM 81-84.
2008 ICC ELECTRICAL CODE W/ISCONSIN COMMERCIAL BUILDING CODE AMENDMENTS - CH. COMM 16.
2009 IMC W/ISCONSIN COMMERCIAL BUILDING CODE AMENDMENTS - CH. COMM 64.
IECC 2009 (WI COMMERCIAL BUILDING CODE, CHAPTER 63)
2009 NFPA-1 (WI COMMERCIAL BUILDING CODE, CHAPTER 8)
ICC/ANSI STANDARD A117.1-2003

A2-ASSEMBLY

EXISTING III-B

IFGC 2009 (WI COMMERCIAL BUILDILING CODE, CHAPTER 65)

ARCHITECTURAL

ARCHITECTURAL SITE PLAN A-1001 A-2001 EXTERIOR ELEVATIONS

LIFE SAFETY PLAN

INTERIORS

DEMOLITION FLOOR PLAN I-1102 DEMOLITION CEILING PLAN FLOOR PLAN
PENETRATION PLAN I-1103 I-1104 I-1105 FF AND F PLAN I-1108 REFLECTED CEILING PLAN FLOOR FINISH PLAN WALL FINISH PLAN I-1109 I-1110 I-2101 INTERIOR ELEVATIONS I-2102 INTERIOR ELEVATIONS

I-2103 I-4101 I-5001 INTERIOR ELEVATIONS ENLARGED BAR PLANS CONSTRUCTION DETAILS I-5003 WORKROOM DETAILS CASEWORK DETAILS I-5008 CASEWORK DETAILS

SCHEDULES I-6002 SCHEDULES

PLUMBING P-0001

PLUMBING SPECIFICATIONS PLUMBING WASTE / DRAIN PLAN P-1102 P-5001 PLUMBING DETAILS & SANITARY ISOMETRIC

FLECTRICAL

BUILDING CODE
PLUMBING CODE
ELECTRICAL CODE
MECHANICAL CODE
ENERGY CODE
FIRE PROTECTION

ACCESSIBILITY OTHER:

ELECTRICAL SPECIFICATIONS E-0001 E-501 ELECTRICAL DETAILS ELECTRICAL POWER PLAN E-1102 LIGHTING PLAN

APPLICABLE BUILDING CODES

CODE CLASSIFICATION

A. OCCUPANCY GROUP:
B. CONSTRUCTION CALSSIFICATION TYPE:
C. AUTOMATIC FIRE SUPPRESSION
SYSTEM INSTALLED:
D. ZONING:

PROJECT CONTACTS

DESIGN MANAGER: STEPHENIE RYCHLIK STARBUCKS COFFEE COMPANY 564 W. RANDOLPH ST., 3RD FLOOR CHICAGO, IL 60661 (312) 380-3906 EXT. 2331 OFFICE (312) 502-6198 CELL SCHAMPIO@STARBUCKS.COM

CONSTRUCTION BRIAN GARVER
MANAGER: STARBUCKS COFFEE COMPANY
564 W. RANDOLPH ST., 3RD FLOOR CHICAGO, IL 60661 (312) 775-6507 EXT. 2219 OFFICE (219) 712-6590 CELL BGARVER@STARBUCKS.COM

MII WALIKEE COLINTY PARKS

MILWAUKEE COUNTY PARKS SUZANNE CARTER 9480 WATERTOWN PLANK ROAD WAUWAUTOSA, WI 53226 (414) 257-6466 FAX

NORR ILLINOIS INC.

325 N. LASALLE STREET, SUITE 700 CHICAGO, IL 60654

(312) 424-2400 PHONE (312) 424-2424 FAX

ALKEMEYER AND ASSOCIATES MEP CONSULTANT OF 335 MARSHALL AVENUE, SUITE 100 ST. LOUIS, MO 63119


(314) 772-0109 FAX



VICINITY PLAN



ARCHITECTURAL SYMBOL LEGEND

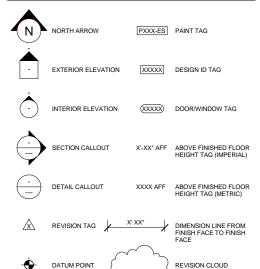

STARBUCKS COFFEE COMPANY

2401 UTAH AVENUE SOUTH SEATTLE, WASHINGTON 98134 (206) 318-1575

ARCHITECT OF RECORD

325 N. LaSalle St. | Suite 700 | Chicago, IL 60654 t 312.424.2400 | f 312.424.2424 | www.norr.com

ENGINEER OF RECORD Phone (314) 772-1782 Fax (314) 772-0108 Engineering Consultant

Description

≘ss: **₹ STREET** FF. WI 53202 ARROW 920 WATER S MILWAUKEE, Ш \propto

STORE #: PROJECT #: 14516-022 CONCEPT: NCS PAI ETTE: HERITAGE ISSUE DATE: 10.17.13

DESIGN MANAGER: S. RYCHLIK LEED® AP-

PRODUCTION DESIGNER: C. ALINOVICH, NORR CHECKED BY K GORIN NORR

SHEET TITLE

GENERAL INFORMATION

As indicated

SCALE:

ABBREVIATIONS 3PL THIRD PARTY LOGISTICS A/C AIR CONDITIONING
ACT ACOUSTICAL CEILING TILE
ADJ ADJUSTABLE
AFF ABOVE FINISHED FLOOR
AMPERE
ARCH ARCHITECT вон BACK OF HOUSE

CABINET
CENTER LINE
CEILING
CONSTRUCTION MANAGER
CENTER
COMMISSIONING
COMMISSIONING AGENT

DEG DET DIA DIM DM DN DEGREE DETAIL DIAMETER DIMENSION DESIGN MANAGER DOWN

EA EACH
EL ELEVATION
EQ EQUAL
EXIST EXISTING
EXT EXTERIOR

"FURNITURE, FIXTURE, AND EQUIPMENT" FURNISHED AND INSTALLED BY OWNER FLOOR FRONT OF HOUSE FOOT/FEET FF&E FIO FLR FOH FT

GROUND GENERAL CONTRACTOR

HC HOLLOW CORE
HDW HARDWARE
HM HOLLOW METAL
HORIZ HORIZONTAL
HR HOUR
HT HEIGHT
HVAC "HEATING, VENTILATING, AND AIR CONDITIONING"

ID INSIDE DIAMETER LL LANDLORD

MAXIMUM
"MECHANICAL, ELECTRICAL, AND PLUMBING"
MANUFACTURER
MINIMUM MAX MEP MFR MIN

NIC NOT IN CONTRAC NL NIGHT LIGHT NTS NOT TO SCALE NOT IN CONTRACT

OC ON CENTER
OD OUTSIDE DIAMETER
OF/CI OWNER FURNISHED/CONTRACTOR INSTALLED
OF/OI OWNER FURNISHED/OWNER INSTALLED

PRODUCTION DESIGNER PLACE PROJECT MANAGER


R RADIUS
RCM RENOVATIONS CONSTRUCTION MANAGER
REF REFERENCE
REC(D) REQUIRE(D)
REV REVISION
RND ROUND

STARBUCKS SOLID CORE SQUARE FEET SHEET SIMILAR SPECIFICATION SQUARE

TEMP TEMPORARY
TYP TYPICAL UON UNLESS OTHERWISE NOTED

VD VENDOR DIRECT VERT VERTICAL VIF VERIFY IN FIELD

LEGEND:

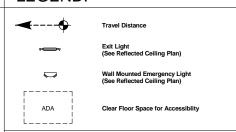


FLAME SPREAD RATING:

Flame spread rating for all proposed interior finishes shall comply with local building code.

INTERIOR FINISH NOTES:

Interior wall and ceiling finish materials shall be Class C with a flame spread rating less than 200 and smoke developed less than 450.

Floor Coverings in the exit path of all common areas shall meet Class A requirements.

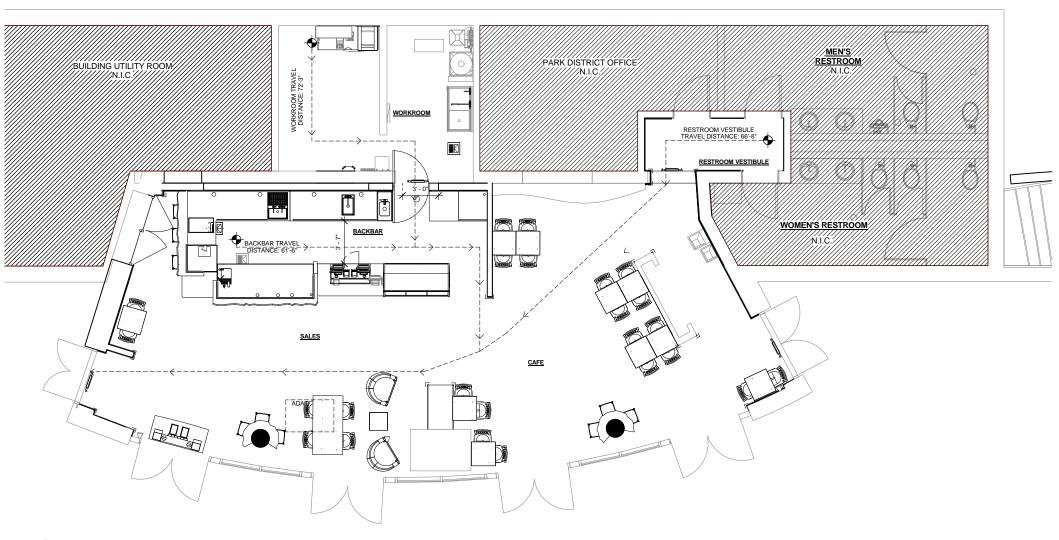

3 LIFE SAFETY PLAN





STARBUCKS COFFEE

COMPANY 2401 UTAH AVENUE SOUTH SEATTLE, WASHINGTON 98134 (206) 318-1575

ARCHITECT OF RECORD



Description

PROJECT NAME:
RED ARROW
PROJECT ADDRESS:
920 WATER STREET
MILWAUKEE, WI 53202

STORE #: PROJECT #: 14516-022 CONCEPT: NCS PALETTE: HERITAGE ISSUE DATE: DESIGN MANAGER: S. RYCHLIK

PRODUCTION DESIGNER: C. ALINOVICH, NORR CHECKED BY: K GORIN NORR

SHEET TITLE:

SCALE:


LEED®AP:

LIFE SAFETY PLAN

1/4" = 1'-0"

SCOPE OF WORK SUMMARY

- 1. DEMOLISH OR REMOVE EXISTING ITEMS AS INDICATED ON DEMOLITION PLAN $\,$
- 2. INSTALL NEW CASEWORK ITEMS AS INDICATED ON CASEWORK PLAN.
- 3. INSTALL NEW AND RELOCATE EXISTING EQUIPMENT AS INDICATED ON FF&E PLAN.
- 4. INSTALL NEW UPPER CUBBIES AS INDICATED ON CASEWORK PLAN.
- 5. INSTALL NEW FURNITURE AS INDICATED ON FF&E PLAN.
- 6. INSTALL NEW PASTRY CASE AS INDICATED ON FF&E PLAN.
- 7. INSTALL NEW WARMING STATION AS INDICATED ON FF&E PLAN.
- 8. INSTALL NEW CONDIMENT CART AS INDICATED ON CASEWORK PLAN.
- 9. INSTALL NEW FLOORING AS INDICATED ON FLOOR FINISH PLAN.
- 10. INSTALL NEW TILE AT BACKBAR. SEE INTERIOR ELEVATIONS FOR CLARIFICATION.
- 11. INSTALL NEW WALL COVERING AND CHAIR RAIL AS INDICATED. SEE INTERIOR ELEVATIONS FOR CLARIFICATION.
- 12. PATCH, PRIME, AND PAINT WALLS, CEILINGS, AND/OR SOFFITS AS INDICATED ON REFLECTED CEILING PLAN AND INTERIOR ELEVATION SHEETS.
- 13. INSTALL NEW LIGHTING AS INDICATED ON REFLECTED CEILING PLAN.
- 14. INSTALL NEW ART AND GRAPHICS AS INDICATED ON INTERIOR ELEVATIONS.
- 15. RELOCATE EXISTING EQUIPMENT IN WORKROOM AS REQUIRED.
- 16. INSTALL NEW WALLS AND DOORS AS INDICATED.

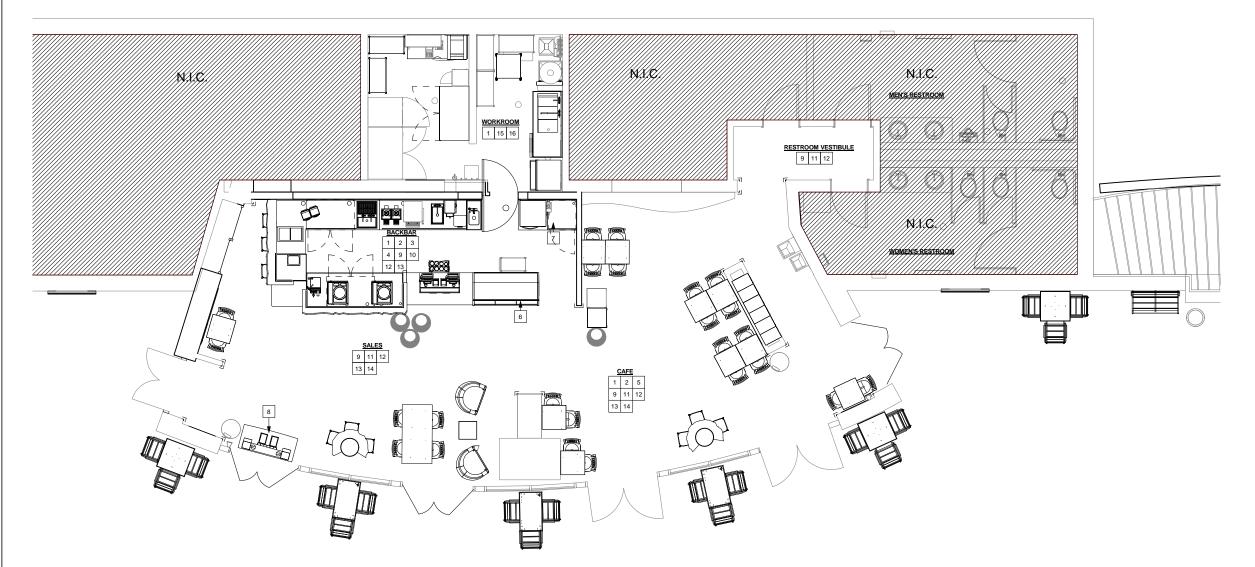

SCOPE OF WORK

Scale: 1/4" = 1'-0"





STARBUCKS COFFEE

COMPANY 2401 UTAH AVENUE SOUTH SEATTLE, WASHINGTON 98134 (206) 318-1575

ARCHITECT OF RECORD

ENGINEER OF RECORD

PROJECT NAME:
RED ARROW
PROJECT ADDRESS:
920 WATER STREET
MILWAUKEE, WI 53202

STORE #: PROJECT #: 14516-022 CONCEPT: PALETTE: HERITAGE

ISSUE DATE: S. RYCHLIK DESIGN MANAGER: LEED® AP:

PRODUCTION DESIGNER: C. ALINOVICH, NORR K. GORIN, NORR CHECKED BY

SCOPE OF WORK PLAN

SCALE:

SECTION 014200 - REFERENCES PART 1 - GENERAL GENERAL INDUSTRY STANDARDS A PPLICABILITY OF STANDARDS: UNLESS THE CONTRACT DOCUMENTS INCLUDE MORE STRINGENT REQUIREMENTS, APPLICABLE CONSTRUCTION INDUSTRY STANDARDS HAVE THE SAME FORCE AND EFFECT AS IF BOUND OR COPIED DIRECTLY INTO THE CONTRACT DOCUMENTS TO THE EXTENT REFERENCED. SUCH STANDARDS ARE MADE A PART OF THE CONTRACT DOCUMENTS BY REFERENCE. PUBLICATION DATES: COMPLY WITH STANDARDS IN EFFECT AS OF DATE OF PUBLICATION DATES: COMPLY WITH STANDARDS IN EFFECT AS OF DATE OF THE CONTRACT DOCUMENTS UNLESS OTHERWISE INDICATED. COPIES OF STANDARDS. EACH ENTITY ENGAGED IN CONSTRUCTION ON PROJECT SHOULD BE FAMILIAR WITH INDUSTRY STANDARDS APPLICABLE TO ITS CONSTRUCTION ACTIVITY. COPIES OF APPLICABLE STANDARDS ARE NOT BOUND WITH THE CONTRACT DOCUMENTS. 1. WHERE COPIES OF STANDARDS ARE NEEDED TO PERFORM A REQUIRED CONSTRUCTION ACTIVITY, OBTAIN COPIES DIRECTLY FROM PUBLICATION SOURCE. ABBREVIATIONS AND ACRONYMS A. INDUSTRY ORGANIZATIONS: WHERE ABBREVIATIONS AND ACRONYMS ARE USED IN SPECIFICATIONS OR OTHER CONTRACT DOCUMENTS, THEY SHALL MEAN THE RECOGNIZED NAME OF THE ENTITIES IN THE FOLLOWING LIST. AMERICAN CONCRETE INSTITUTE AMERICAN CONCRETE INSTITUTE AMERICAN HARDBOARD ASSOCIATION AMERICAN HARDBOARD ASSOCIATION AMERICAN INSTITUTE OF TIMBER CONSTRUCTION AMERICAN NATIONAL STANDARDS INSTITUTE APA- THE ENGINEERED WOOD ASSOCIATION AMERICAN SOCIETY OF HEATING, REFRIGERATING AND AIR-CONDITIONING ENGINEERS ASTM INTERNATIONAL (AMERICAN SOCIETY FOR TESTING AND MATERIALS INTERNATIONAL) ARCHITECTURAL WOOD WORK INSTITUTE AMERICAN WOOD PROTECTION ASSOCIATION (FORMERLY: AMERICAN WOOD PRESSERVERS' ASSOCIATION) CARPET AND RUG INSTITUTE (THE) COOL ROOF RATING COUNCIL ASTM CRI CRRC CSA CSA ADIAN STANDARDS ASSOCIATION CANADIAN STANDARDS ASSOCIATION CSA INTERNATIONAL (FORMERLY: IAS - INTERNATIONAL APPROVAL SERVICES) CONSTRUCTION SPECIFICATIONS INSTITUTE (THE) ETL SEMCO NTERTEK ETL SEMCO FORMERLY: ITS - INTERTEK TESTING SERVICE NA) FM GLOBAL FM GLOBAL -M GLOBAL (FORMERLY: FMG - FM GLOBAL) FOREST STEWARDSHIP COUNCIL HARDWOOD PLYWOOD & VENEER ASSOCIATION INTERNATIONAL ORGANIZATION FOR STANDARDIZATION ISO ITS INTERTEK TESTING SERVICE NA (NOW ETL SEMCO) (NOW E IL SEMCO) MAPLE FLOORING MANUFACTURERS ASSOCIATION, INC. MASTER PAINTERS INSTITUTE MPI NFPA (NATIONAL FIRE PROTECTION ASSOCIATION) NOFMA: THE WOOD FLOORING MANUFACTURERS ASSOCIATION (FORMERLY: NATIONAL OAK FLOORING MANUFACTURERS) NOFMA ASSOCIATION) INTERTAK ASSOCIATION) INTERTAK STEEL DOOR INSTITUTE IA SHEET METAL AND AIR CONDITIONING CONTRACTORS' NATIONAL ASSOCIATION UNDERWRITERS LABORATORIES INC. U.S. GREEN BUILDING COUNCIL WEST COAST LUMBER INSPECTION BUREAU WOODWORK INSTITUTE (FORMERLY: WIC - WOODWORK INSTITUTE OF CALIFORNIA) CODE AGENCIES: WHERE ABBREVIATIONS AND ACRONYMS ARE USED IN SPECIFICATIONS OR OTHER CONTRACT DOCUMENTS, THEY SHALL MEAN THE RECOGNIZED NAME OF THE ENTITIES IN THE FOLLOWING LIST. DEUTSCHES INSTITUT FUR NORMUNG E.V. INTERNATIONAL CODE COUNCIL SE ICC EVALUATION SERVICE, INC. FEDERAL GOVERNMENT AGENCIES: WHERE ABBREVIATIONS AND ACRONYMS ARE USED IN SPECIFICATIONS OR OTHER CONTRACT ASSOCIATION) ACRONYMS ARE USED IN SPECIFICATIONS OR OTHER CONTRACT DOCUMENTS, THEY SHALL MEAN THE RECOGNIZED NAME OF THE ENTITIES IN THE FOLLOWING LIST. ENVIRONMENTAL PROTECTION AGENCY STANDARDS AND REGULATIONS: WHERE ABBREVIATIONS AND ACRONYMS ARE USED IN SPECIFICATIONS OR OTHER CONTRACT DOCUMENTS, THEY

ADAAG

GENERAL CONDITIONS GENERAL CONDITIONS (CONTINUED)

SECTION 017419 - CONSTRUCTION WASTE MANAGEMENT AND DISPOSA

SALVAGING NONHAZARDOUS DEMOLITION AND CONSTRUCTION WASTE.
RECYCLING NONHAZARDOUS DEMOLITION AND CONSTRUCTION WASTE. DISPOSING OF NONHAZARDOUS DEMOLITION AND CONSTRUCTION WASTE.

CONSTRUCTION WASTE: BUILDING AND SITE IMPROVEMENT MATERIALS. AND OTHER SOLID WASTE RESULTING FROM CONSTRUCTION, REMODELING RENOVATION, OR REPAIR OPERATIONS. CONSTRUCTION WASTE INCLUDES DEMOLITION WASTE: BUILDING AND SITE IMPROVEMENT MATERIALS

RESULTING FROM DEMOLITION OR SELECTIVE DEMOLITION OPERATIONS. DISPOSAL: REMOVAL OFF-SITE OF DEMOLITION AND CONSTRUCTION WASTE AND SUBSEQUENT SALE, RECYCLING, REUSE, OR DEPOSIT IN LANDFILL OR INCINERATOR ACCEPTABLE TO AUTHORITIES HAVING JURISDICTION.
RECYCLE: RECOVERY OF DEMOLITION OR CONSTRUCTION WASTE FOR

SUBSEQUENT PROCESSING IN PREPARATION FOR REUSE SALVAGE: RECOVERY OF DEMOLITION OR CONSTRUCTION WASTE AND SUBSEQUENT SALE OR REUSE IN ANOTHER FACILITY.

SALVAGE AND REUSE: RECOVERY OF DEMOLITION OR CONSTRUCTION WASTE AND SUBSEQUENT INCORPORATION INTO THE WORK.

WAS IE AND SUBSEQUENT INCOMES AND ANALYSE PERFORMANCE REQUIREMENTS
A. END-OF-PROJECT RATES FOR SALVAGE/RECYCLING: [75] PERCENT.
ACTION SUBMITTALS
A. WASTE MANAGEMENT PLAN: SUBMIT PLAN WITHIN 7 DAYS OF DATE
ESTABLISHED FOR COMMENCEMENT OF THE WORK.

1. TYPES AND QUANTITIES OF DEMOLITION AND CONSTRUCTION
MACKET

WASTE.
2. TYPE OF WASTE AND WHETHER IT WILL BE SALVAGED, RECYCLED, OR DISPOSED OF IN LANDFILL OR INCINERATOR.
3. NET ADDITIONAL COST OR NET SAVINGS RESULTING FROM WASTE MANAGEMENT PLANT.
INFORMATION SUBMITTALS
A. WASTE REDUCTION PROGRESS REPORTS: CONCURRENT WITH EACH APPLICATION FOR PAYMENT, SUBMIT REPORT INDICATING TYPE OF WASTE AND WHETHER IT HAS BEEN SALVAGED, RECYCLED, OR DISPOSED OF IN LANDFILL OR INCINERATOR. LANDFILL OR INCINERATOR

LANDFILL OR INCINERATOR.
WASTE DISPOSAL RECORDS: INDICATE RECEIPT AND ACCEPTANCE OF WASTE MATERIAL BY ACCEPTING AND PROCESSING FACILITIES LICENSED TO ACCEPT THEM. INCLUDE MANIFESTS, TYPE OF MATERIAL, WEIGHT OR VOLUME TICKETS, RACE JIPTS, AND INVOICES.
LEED SUBMITTAL: CWM REPORTING TEMPLATE, TABULATING TOTAL

WASTE MATERIAL, QUANTITIES DIVERTED AND MEANS BY WHICH IT IS DIVERTED, AND STATEMENT THAT REQUIREMENTS FOR THE CREDIT HAVE

RECYCLING WASTE RECYCLING INCENTIVES: REVENUES AND OTHER INCENTIVES FOR

RECYCLING WILL ACCRUE TO OWNER

EXISTING CONDITIONS

SECTION 024119 - SELECTIVE DEMOLITION

DEMOLITION AND REMOVAL OF [PORTIONS OF A BUILDING OR STRUCTURE] [SELECTED SITE ELEMENTS].
HISTORIC ITEMS REMOVED AND SALVAGED FOR OWNER.

SUBMITTALS

SCHEDULE OF SELECTIVE DEMOLITION ACTIVITIES: INDICATE THE FOLLOWING:
1. DETAILED SEQUENCE OF SELECTIVE DEMOLITION AND REMOVAL

DETAILED SEQUENCE OF SELECTIVE DEMOLITION AND REMOVAL WORK, WITH STARTING AND ENDING DATES FOR EACH ACTIVITY. ENSURE OWNER'S [BUILDING MANAGER'S] [AND] IOTHER TENANTS'] ON-SITE OPERATIONS ARE UNINITERRUPTED.
INTERRUPTION OF UTILITY SERVICES. INDICATE HOW LONG UTILITY SERVICES WILL BE INTERRUPTED.
COORDINATION FOR SHUTOFF, CAPPING, AND CONTINUATION OF UTILITY SERVICES.
USE OF ELVATOR AND STAIRS.
COORDINATION OF OWNER'S CONTINUING OCCUPANCY OF PORTIONS OF EXISTING BUILDING AND OF OWNER'S PARTIAL OCCUPANCY OF COMPLETED WORK.
DITIONS

PROJECT CONDITIONS

A. OWNER WILL [NOT] OCCUPY PORTIONS OF BUILDING IMMEDIATELY
ADJACENT TO SELECTIVE DEMOLITION AREA

B. HAZARDOUS MATERIALS: UNKNOWN WHETHER HAZARDOUS MATERIALS WILL
BE ENCOUNTERED. IF ENCOUNTERED, OWNER WILL REMOVE HAZARDOUS
MATERIALS UNDER A SEPARATE CONTRACT.

EXECUTION
A. UTILITY SERVICES AND MECHANICAL/ELECTRICAL SYSTEMS: MAINTAINED TO

UTILITY SERVICES AND MECHANICALELECTION
OCCUPIED FACILITIES.

1. SHUT OFF: BY [OWNER] [BUILDING MANAGER] [CONTRACTOR].
SITE ACCESS AND TEMPORARY CONTROLS: MINIMUM INTERFERENCE WITH
ROADS, STREETS, WALKS, WALKWAYS, AND OTHER ADJACENT OCCUPIED

AND USED FACILITIES
TEMPORARY FACILITIES: PROVIDE TEMPORARY BARRICADES AND OTHER PROTECTION REQUIRED TO PREVENT INJURY TO PEOPLE AND DAMAGE TO ADJACENT BUILDINGS AND FACILITIES TO REMAIN.

ADJACENT BUILDINGS AND FACILITIES TO REMAIN.
TEMPORARY SHORING: PROVIDE AND MAINTAIN SHORING, BRACING, AND
STRUCTURAL SUPPORTS AS REQUIRED TO PRESERVE STABILITY AND
PREVENT MOVEMENT, SETTLEMENT, OR COLLAPSE OF CONSTRUCTION AND FINISHES TO REMAIN, AND TO PREVENT UNEXPECTED OR UNCONTROLLED MOVEMENT OR COLLAPSE OF CONSTRUCTION BEING DEMOLISHED. REMOVED AND SALVAGED ITEMS: CLEANED, CRATED, STORED, AND

TRANSPORTED TO OWNER'S [ON] -SITE STORAGE AREA.
REMOVED AND REINSTALLED ITEMS: CLEANED, REPAIRED, CRATED,

STORED, AND REINSTALLED. EXISTING ITEMS TO REMAIN: EXISTING CONSTRUCTION PROTECTED

AGAINST DAMAGE.
DISPOSAL OF DEMOLISHED ITEMS:

BURNING: NOT PERMITTED.
DISPOSAL: COMPLY WITH REQUIREMENTS SECTION 017419
"CONSTRUCTION WASTE MANAGEMENT AND DISPOSAL".

CONCRETE

SECTION 033000 - CAST-IN-PLACE CONCRETE

CAST-IN-PLACE CONCRETE, INCLUDING FORMWORK, REINFORCEMENT CONCRETE MATERIALS, MIXTURE DESIGN, PLACEMENT PROCEDURES AND FINISHES, FOR THE FOLLOWING:

FOOTINGS. FOUNDATION WALLS.

SUBMITTALS PRODUCT DATA: FOR EACH TYPE OF PRODUCT INDICATED

DIAWINGS: REINFORCING: PLACING DRAWINGS THAT DETAIL FABRICATION, BENDING, AND PLACEMENT. INCLUDE BAR SIZES, LENGTHS, MATERIAL, GRADE, BAR SCHEDILES, STIRRUP SPACING, BENT BAR DIAGRAMS, BAR ARRANGEMENT, SPLICES AND LAPS, MECHANICAL CONNECTIONS, TIE SPACING, HOOP SPACING, AND SUPPORTS FOR CONCRETE REINFORCEMENT. SLAB LAYOUTS: DIMENSION LOCATIONS OF CONTRO

EXPANSION, AND CONSTRUCTION JOINTS. RELATE TO BUILDING DESIGN MIXTURES: FOR EACH CONCRETE MIXTURE. SUBMIT ALTERNATE DESIGN MIXTURES: FOR EACH CONCRETE MIXTURE. SUBMIT ALTERNATE DESIGN MIXTURES WHEN CHARACTERISTICS OF MATERIALS, PROJECT CONDITIONS, WEATHER, TEST RESULTS, OR OTHER CIRCUMSTANCES

WARRANT ADJUSTMENTS.

1. INDICATE AMOUNTS OF MIXING WATER TO BE WITHHELD FOR LATER ADDITION AT PROJECT SITE.

CERTIFICATIONS: SUBMIT MILL CERTIFICATES FOR CEMENT, AGGREGATES, AND REINFORCING.

MATERIALS
A. STEEL REINFORCEMENT:

STEEL REINFORCEMENT:

1. REINFORCING BARS: DEFORMED.

a. MINIMUM RECYCLED CONTENT: 60%.

2. PLAIN-STEEL WELDED WIRE REINFORCEMENT: ASTM A 185, PLAIN, FABRICATED FROM AS-DRAWN STEEL WIRE INTO FLAT SHEETS.

CONCRETE MATERIALS:

RETE MATERIALS:
PORTLAND CEMENT: ASTM C 150, TYPE I, GRAY, SUPPLEMENT
WITH THE FOLLOWING:
a. FLY ASH: ASTM C 618, CLASS F OR C.
b. GROUND GRANULATED BLAST-FURNACE SLAG: ASTM
C 989, GRADE 100 OR 120.
AGGREGATE: NORMAL WEIGHT:
WATER: ASTM C 94/C 94/M.
ADMIXTURES: PROVIDE ADMIXTURES CERTIFIED BY
MANUFACTUREN TO BE COMPATIBLE WITH OTHER ADMIXTURES
AND THAT WILL NOT CONTRIBUTE WATER-SOLUBLE CHLORIDE
IONS EXCEEDING THOSE PERMITTED IN HARDENED CONCRETE.
DO NOT USE CALCLIUM CHLORIDE OR ADMIXTURES CONTAINING DO NOT USE CALCIUM CHLORIDE OR ADMIXTURES CONTAINING

CALCIUM CHLORIDE.

a. AIR-ENTRAINMENT: ASTM C 260.

b. WATER-REDUCING ADMIXTURE: ASTM C 494/C 494M,

B. WATER-REDUCING ADMIXTURE: ASTM C 494/C 494M, TYPE A.
 C. HIGH-RANGE, WATER-REDUCING ADMIXTURE: ASTM C 494/C 494M, TYPE F.
WATERSTOPS: FLEXIBLE RUBBER.
PLASTIC VAPOR RETARBORE: ASTM E 1745, CLASS A. INCLUDE MANUFACTURER'S RECOMMENDED ADHESIVE OR PRESSURE-SENSITIVE IONET 1746.

MANUFACTURER'S RECOMMENDED ADHESIVE OR PRESSURE-SENSITIVE JOINT TAPE.
CURING MATERIALS: WATERBORNE, MONOMOLECULAR FILM FORMING, MANUFACTURED FOR APPLICATION TO FRESH CONCRETE.
RELATED MATERIALS:

1. EXPANSION- AND ISOLATION-JOINT-FILLER STRIPS ASTM D 1751, ASPHALT-SATURATED CELLULOSIC FIBER OR ASTM D 1752, CORK OR SELF-EXPANDING CORK.
2. BONDING AGENT: ASTM C 1059(C 1059M, TYPE II, NON-REDISPERSIBLE, ACRYLIC EMULSION OR STYRENE BUTADIENE.

SUTADIENE. NON-SHRINK GROUTS: ASTMIC 1107, GRADE B: NON-SHRINK

NON-SHRINK GROUTS: ASTM C 1107, GRADE B: NON-SHRINK NON-CATALYZED NATURAL AGGREGATE GROUT; MINIMUM COMPRESSIVE STRENGTH OF 7000 PSI AT 28 DAYS; 25 TO 30 SECOND FLOW WHEN TESTED IN ACCORDANCE WITH ASTM C 939 AT 45 TO 90 DEGREES F; CEMENT GRAY IN COLOR FORM RELEASE COATING: WATER BASED TYPE; VOC <150G/I;

NOX-CRETE "UTILITY RELEASE, CRESSET CHEMICAL COMPANY CRETE 20 VOC." OR APPROVED: NON STAINING. REPAIR MATERIALS:

REPAIR UNDERLAYMENT: CEMENT-BASED, POLYMER-MODIFIED. SELF-LEVELING PRODUCT THAT CAN BE APPLIED IN THICKNESSES FROM 1/8 INCH (3.2 MM) AND THAT CAN BE FEATHERED AT EDGES

TO MATCH ADJACENT FLOOR ELEVATIONS. ICH ADJACENT FLOOR ELEVATIONS. CEMENT BINDER: ASTM C 150, PORTLAND CEMENT OR HYDRAULIC OR BLENDED HYDRAULIC CEMENT AS DEFINED IN ASTM C 219.

IN ASTM C 219.
PRIMER: PRODUCT OF UNDERLAYMENT MANUFACTURER
RECOMMENDED FOR SUBSTRATE, CONDITIONS, AND

RECOMMENDED FOR SUBSTRATE, CONDITIONS, AND APPLICATION.

c. AGGREGATE: WELL-GRADED, WASHED GRAVEL, 1/8 TO 1/4 INCH (3.2 TO 6 MM) OR COARSE SAND AS RECOMMENDED BY UNDERLAYMENT MANUFACTURER.

d. COMPRESSIVE STRENGTH: NOT LESS THAN 4100 PSI (29 MPA) AT 28 DAYS WHEN TESTED ACCODING TO ASTM C 109/C 109M.

REPAIR OVERLAYMENT: CEMENT-BASED, POLYMER-MODIFIED, SELF-LEVELING PRODUCT HAT CAN BE APPLIED IN THICKNESSES FROM 1/8 INCH 1/32 MM) AND THAT CAN DE FEATHERED AT EDGES TO MATCH ADJACENT FLOOR ELEVATIONS.

a. CEMENT BINDER: ASTM C 150, PORTLAND CEMENT OR HYDRAULIC OR BLENDED HYDRAULIC CEMENT AS DEFINED IN ASTM C 219.

b. PRIMER: PRODUCT OF TOPPING MANUFACTURER RECOMMENDED FOR SUBSTRATE, CONDITIONS, AND APPLICATION.

APPLICATION.
AGGREGATE: WELL-GRADED, WASHED GRAVEL, 1/8 TO

AGGREGATE: WELL-GRADED, WASHED GRAVEL, 1/8 I 1/4 INCH (3.2 TO 6 MM) OR COARSE SAND AS RECOMMENDED BY TOPPING MANUFACTURER. COMPRESSIVE STRENGTH: NOT LESS THAN 5000 PSI

(34.5 MPA) AT 28 DAYS WHEN TESTED ACCORDING TO ASTM C 109/C 109M.

1.4 INSTALLATION FLOOR AND SLAB FINISHES:

IR AND SLAB FINISHES:
FLOAT: SURFACES TO RECEIVE TROWEL FINISH.
TROWEL: SURFACES EXPOSED TO VIEW, AND SURFACES TO BE
COVERED WITH RESILIENT FLOORING, CARPET, CERAMIC OR
QUARRY TILE SET OVER A CLEAVAGE MEMBRANE, PAINT, OR
ANOTHER THIN-FILM-FINISH COATING SYSTEM.
TROWEL AND FINE BROOM: SURFACES TO BE COVERED WITH
CERAMIC OR QUARRY TILE INSTALLED BY EITHER THICKSET OR
THIN-SET METHOD.
BROOM: EXTERIOR CONCRETE PLATFORMS, STEPS, AND RAMPS.
Y CONTROL

FIELD QUALITY CONTROL
 A. TESTING: BY [CONTROL]
 A. TESTING: BY [CONTRACTOR]-ENGAGED AGENCY.
 B. INSPECTIONS: BY OWNER-ENGAGED SPECIAL INSPECTOR.

END OF SECTION 033000

CONCRETE (CONTINUED)

SECTION 033500 - CONCRETE FINISHING

SUBMITTALS

A. QUALIFICATION DATA: FOR QUALIFIED APPLICATOR.
B. MATERIAL CERTIFICATES.
FLOOR AND SLAB TREATMENTS

A. VOC CONTENT: FLOOR TREATMENTS SHALL HAVE A VOC CONTENT OF 200 G/L
OR LESS WHEN CALCULATED ACCORDING TO 40 CFR 59, SUBPART D (EPA

OR LESS WHEN CALCULATED ACCORDING TO 40 CFR 59, SUPPART DIFFA
UNPIGMENTED MINERAL DRY-SHAKE FLOOR HARDENER: FACTORY-PACKAGED
DRY COMBINATION OF PORTLAND CEMENT, GRADED QUARTZ AGGREGATE,
AND PLASTICIZING ADMIXTURE.
PIGMENTED MINERAL DRY-SHAKE FLOOR HARDENER: FACTORY-PACKAGED,
DRY COMBINATION OF PORTLAND CEMENT, GRADED QUARTZ AGGREGATE,
COLOR PIGMENTS, AND PLASTICIZING ADMIXTURE. USE COLOR PIGMENTS
THAT ARE FINELY GROUND, NONFADING MINERAL OXIDES INTERGROUND WITH
CFMENT

CEMENT.
FLOOR TREATMENTS
VOC CONTENT: LIQUID FLOOR TREATMENTS SHALL HAVE A VOC CONTENT OF
200 GAL OR LESS WHEN CALCULATED ACCORDING TO 40 CFR 59, SUBPART D
(FOR METALOR 41)

PENETRATING LIQUID FLOOR TREATMENT: CLEAR, CHEMICALLY REACTIVE WATERBORNE SOLUTION OF INORGANIC SILICATE OR SILICONATE MATERIALS.
AND PROPRIETARY COMPONENTS; ODORLESS; THAT PENETRATES, HARDENS, AND DENSIFIES CONCRETE SURFACES.
PENETRATING LIQUID FLOOR TREATMENTS FOR POLISHED CONCRETE FINISH:

CLEAR, WATERBORNE SOLUTION OF INORGANIC SILICATE OR SILICONATE MATERIALS AND PROPRIETARY COMPONENTS; ODORLESS; THAT PENETRATES, HARDENS, AND IS SUITABLE FOR POLISHED CONCRETE SURFACES. INSTALLATION

DRY-SHAKE FLOOR HARDENER FINISH: AFTER INITIAL FLOATING, APPLY DRY-SHAKE FLOOR HARDENER TO SURFACES
PENETRATING LIQUID FLOOR TREATMENT: PREPARE, APPLY, AND FINISH
PENETRATING LIQUID FLOOR TREATMENT ACCORDING TO MANUFACTURER'S

WRITTEN INSTRUCTIONS.
C. SEALING COAT. UNIFORMLY APPLY A CONTINUOUS SEALING COAT OF CURING AND SEALING COAT. UNIFORMLY APPLY A CONTINUOUS SEALING COAT OF CURING AND SEALING COMPOUND TO HARDBENED CONCRETE BY POWER SPRAY OR ROLLER ACCORDING TO MANUFACTURER'S WRITTEN INSTRUCTIONS.
D. PROTECT LIQUID FLOOR TREATMENT FROM DAWAGE AND WEAR DURING THE REMAINDER OF CONSTRUCTION PERIOD. USE PROTECTIVE WITHOOS AND MATERIALS, INCLUDING TEMPORARY COVERING, RECOMMENDED IN WRITING BY LIQUID FLOOR TREATMENTS INSTALLER.

END OF SECTION 033500

SECTION 035416 - HYDRAULIC-CEMENT-BASED UNDERLAYMENT

HYDRAULIC-CEMENT-BASED UNDERLAYMENT FOR USE BELOW INTERIOR FLOOR COVERINGS. MATERIALS

UNDERLAYMENT: HYDRAULIC-CEMENT-BASED, POLYMER-MODIFIED, SELF-UNDERLAYMENT: HYDRAULIC-CEMENT-BASED, POLYMER-MODIFIED, SELF-LEVELING PRODUCT THAT CAN BE APPLIED IN MINIMUM UNIFORM THICKNESS OF 1/4 INCH (6MM) AND THAT CAN BE FEATHERED AT EDGES TO MATCH ADJACENT FLOOR ELEVIATIONS.

1. CEMENT BINDER: PORTLAND CEMENT, OR OTHER HYDRAULIC OR BLENDED HYDRAULIC CEMENT.
PRIMER: PRODUCT OF UNDERLAYMENT MANUFACTURER RECOMMENDED IN WRITING FOR SUBSTRATE, CONDITIONS, AND APPLICATION INDICATED.

1. PRIMER SHALL HAVE A VOC CONTENT OF 20 GL OR LESS WHEN CALCULATED ACCORDING TO 40 CFR 59, SUBPART D.

METALS

SECTION 055000 - METAL FABRICATIONS

STEEL FRAMING AND SUPPORTS FOR MECHANICAL AND ELECTRICAL

STEEL FRAMING AND SUPPORTS FOR MECHANICAL AND ELECTRICAL EQUIPMENT. STEEL FRAMING AND SUPPORTS FOR APPLICATIONS WHERE FRAMING AND SUPPORTS ARE NOT SPECIFIED IN OTHER SECTIONS. SHELF ANGLES. METAL BOLLARDS.

D. METAL BOLLARDS.
SUBMITTALS
A. PRODUCT DATA: FOR THE FOLLOWING:
1. PAINT PRODUCTS.
2. GROUT.
3. ALL PREFABRICATED PRODUCTS.
B. SHOP DRAWINGS: SHOW FABRICATION AND INSTALLATION DETAILS FOR METAL FABRICATIONS.
1. INCLUDE PLANS, ELEVATIONS, SECTIONS, AND DETAILS OF METAL FABRICATIONS AND THEIR CONNECTIONS. SHOW ANCHORAGE AND ACCESSORY ITEMS.
2. PROVIDE TEMPLATES FOR ANCHORS AND BOLTS SPECIFIED FOR INSTALLATION UNDER OTHER SECTIONS.

PRODUCTS MATERIALS: STEEL PLATES, SHAPES, AND BARS, STEEL PIPE, SLOTTED

LOW-EMITTING PRIMER: METAL PRIMER SHALL HAVE A VOC CONTENT

OF 200 G/L OR LESS WHEN CALCULATED ACCORDING TO 40 CFR 59. OF 200 G/L OR LESS WHEN CALCULATED ACCORDING TO 40 CFK 59, SUBPART 0 (EPA METHOD 24).

MISCELLANEOUS FRAMING AND SUPPORTS:

1. STEEL FRAMING AND SUPPORTS FOR MECHANICAL AND ELECTRICAL EQUIPMENT, APPLICATIONS WHERE FRAMING AND SUPPORTS ARE NOT SPECIFIED IN OTHER SECTIONS.

GALVANIZE WHERE INDICATED. PRIME WITH ZINC-RICH PRIMER WHERE INDICATED.

a. ZINC-RICH PRIMER SHALL HAVE A VOC CONTENT OF 340 G/L
OR LESS WHEN CALCULATED ACCORDING TO 40 CFR 59,
SUBPART O LEPA METHOD 24).
LOOSE STEEL LINTELS, GALVANIZED AT EXTÉRIOR WALLS.

SHELF ANGLES, GALVANIZED.
STEEL WELD PLATES AND ANGLES NOT SPECIFIED IN OTHER SECTIONS, FOR

CASTING INTO CONCRETE.
METAL BOLLARDS: SCHEDULE 40 STEEL PIPE.

STARBUCKS COFFEE **COMPANY**

2401 UTAH AVENUE SOUTH SEATTLE, WASHINGTON 98134 (206) 318-1575

THESE DRAWINGS AND SPECIFICATIONS ARE CONFIDENTIAL AND SHALL REMAN INE SOLE PROPERTY OF STANBLUCKS CORPOLATION, WHICH REMAN INE SOLE PROPERTY OF STANBLUCKS CORPOLATION, WHICH CAN PROPERTY OF STANDARD S

ARCHITECT OF RECORD

ENGINEER OF RECORD

Phone (314) 772-1782 Fax (314) 772-0108 Engineering Consultant

Descript

ROW 920 WATER S MILWAUKEE, ARI Δ Ш \simeq

STORE #: PROJECT #: 14516-022 CONCEPT NCS PAI ETTE HERITAGE ISSUE DATE: 10.17.13 DESIGN MANAGER: S. RYCHLIK LEED® AP-

PRODUCTION DESIGNER: C. ALINOVICH, NORR

CHECKED BY SHEET TITLE

> **DESIGN SPECIFICATIONS**

K GORIN NORR

G-0010

SCALE:

WITNESS, PREPARE, AND MAINTAIN COMPLETED FUNCTIONAL TESTING CHECKLISTS. PREPARE AND MAINTAIN THE ISSUES LOG.

COMMISSIONING SUMMARY REPORT.

COMPILE COMMISSIONING DOCUMENTS, RESULTS, AND DEFICIENCIES; INCLUDE THEM IN THE SYSTEMS MANUAL AND

MEMBERS REPRESENTING OWNER, INCLUDING COMMISSIONING AGENT (CXA), FACILITY USER AND OPERATION AND MAINTENANCE PERSONNEL, AND ARCHITECT AND ENGINEERING DESIGN PROFESSIONALS.
CONTRACTOR'S RESPONSIBILITIES: CONTRACTOR SHALL ASSIGN REPRESENTATIVES WITH EXPERTISE AND AUTHORITY TO ACT ON ITS
BEHALF AND SHALL SCHEDULE THEM TO PARTICIPATE IN AND PERFORM
COMMISSIONING PROCESS ACTIVITIES INCLUDING, BUT NOT LIMITED TO,

SECTION 019113 - GENERAL COMMISSIONING REQUIREMENTS

COMMISSIONING TEAM:

IN THE FOLLOWING LIST.

AMERICANS WITH DISABILITIES ACT (ADA)

THE FOLLOWING:

1. INTEGRATE AND COORDINATE COMMISSIONING PROCESS ACTIVITIES

SHALL MEAN THE RECOGNIZED NAME OF THE STANDARDS AND REGULATIONS

ARCHITECTURAL BARRIERS ACT (ABÀ) ACCESSIBILITY GUIDELINES FOR BUILDINGS AND FACILITIES

AVAILABLE FROM U.S. ACCESS BOARD
CODE OF FEDERAL REQUIATIONS
AVAILABLE FROM GOVERNMENT PRINTING OFFICE
STATE GOVERNMENT AGENCIES: WHERE ABBREVIATIONS AND ACRONYMS
ARE USED IN SPECIFICATIONS OR OTHER CONTRACT DOCUMENTS, THEY
SHALL MEAN THE RECOGNIZED NAME OF THE ENTITIES IN THE FOLLOWING
LIST.

CALIFORNIA DEPARTMENT OF HEALTH SERVICES
CALIFORNIA DEPARTMENT OF PUBLIC HEALTH, INDOOR AIR QUALITY
SECTION

ISSIDITING TEAMS.

MEMBERS REPRESENTING CONTRACTOR, INCLUDING PROJECT
SUPERINTENDENT AND SUBCONTRACTORS, INSTALLERS, SUPPLIERS,
AND SPECIALISTS.

WITH CONSTRUCTION SCHEDULE.
REVIEW AND ACCEPT COMMISSIONING CHECKLISTS AND PROCESS
TEST PROCEDURES PROVIDED BY THE COMMISSIONING AGENT (CXA).
SUPPORT COMMISSIONING INSTALLATION REVIEW AND PROCESS

SUPPORT COMMISSIONING INSTALLATION REVIEW AND PROCESS TEST PROCEDURES.
EVALUATE INSTALLATION AND PERFORMANCE DEFICIENCIES IDENTIFIED IN PEPORTS AND, IN COLLABORATION WITH ENTITY RESPONSIBLE FOR SYSTEM AND EQUIPMENT INSTALLATION, RECOMMEND CORRECTIVE ACTION.
COOPERATE WITH THE COMMISSIONING TEAM FOR RESOLUTION OF ISSUES RECORDED IN THE ISSUES LOG.
ISSIONING AGENTS (CXAS) RESPONSIBILITIES: ORGANIZE AND LEAD COMMISSIONING TEAM.
PROVIDE AND MANAGE COMMISSIONING PLAN.
PROVIDE AND MANAGE COMMISSIONING PLAN.
PROVIDE AND MANAGE COMMISSIONING PLAN.
PROVIDE PROJECT-SPECIFIC CHECKLISTS AND TEST PROCEDURES.
WITHESS, PREPARE AND MAINTAIN COMPLETED INSTALLATION VERIFICATION CHECKLISTS.
WITHESS SYSTEMS, ASSEMBLIES, EQUIPMENT, AND COMPONENT STARTUP.
WITNESS, SYSTEMS, ASSEMBLIES, EQUIPMENT, AND COMPONENT STARTUP.

COMMISSIONING SUMMARY REPORT.
REVIEW COMMISSIONING REPORT WITH COMMISSIONING TEAM AND
IMPLEMENT PLAN TO RESOLVE DEFICIENCIES.END OF SECTION 019113

TITEMS IN CONTACT WITH ROOFING OR WATERPROOFING.
ITEMS IN CONTACT WITH CONCRETE OR MASONRY.
FRAMING LESS THAN 18 INCHES (460 MM) ABOVE GROUND IN

FLOOR PLATES INSTALLED OVER CONCRETE SLABS-ON-GRADE.

FIRE-RETARDANT-TREATED MATERIALS:

1. EXTERIOR TYPE FOR EXTERIOR LOCATIONS AND WHERE INDICATED. INTERIOR TYPE A UNLESS OTHERWISE INDICATED.

APPLICATION: ITEMS INDICATED AND THE FOLLOWING:

a. FRAMING FOR RAISED PLATFORMS.

CONCEALED BLOCKING. ROOF FRAMING AND BLOCKING.

FRAMING:
1. NON-LOAD-BEARING INTERIOR PARTITIONS: CONSTRUCTION OR NO. 2

MISCELLANEOUS LUMBER:

DIMENSION LUMBER:

UTILITY SHELVING: 19 PERCENT MAXIMUM MOISTURE CONTENT.

CONCEALED BOARDS: 19 PERCENT MAXIMUM MOISTURE CONTENT.

CONCEALED BOARDS: 19 PERCENT MAXIMUM MOISTURE CONTENT.

PLYWOOD BACKING PANELS: EXPOSURE 1, C-D PLUGGED [, FIRE-RETARDANT TREATED]

PLYWOOD BACKING FORESS. IT TREATED.
FASTENERS: HOT-DIP GALVANIZED STEEL WHERE EXPOSED TO WEATHER, IN GROUND CONTACT, IN CONTACT WITH TREATED WOOD, OR IN AREA OF HIGH RELATIVE HUMIDITY.

I. METAL: GALVANIZED STEEL; HOT-DIP HEAVY GALVANIZED STEEL FOR WOOD-PRESERVATIVE-TREATED LUMBER AND WHERE INDICATED. ADHESIVES: ADHESIVES SHALL HAVE A VOC CONTENT OF 70 GLOR LESS WHEN CALCULATED ACCORDING TO 40 CFR 59, SUBPART D (EPA METHOD 24).

INSTALLATION
A. FURRING TO RECEIVE PLYWOOD OR HARDBOARD PANELING: 1-BY-3-INCH
A. FURRING TO RECEIVE PLYWOOD OR HARDBOARD PANELING: 1-BY-3-INCH NOMINAL-SIZE (19-BY-63-MM ACTUAL-SIZE) FURRING AT [24 INCHES (610 MM)]

[600 MM] O.C.
FURRING TO RECEIVE GYPSUM BOARD: 1-BY-2-INCH NOMINAL-SIZE (19-BY-38-MM ACTUAL-SIZE) FURRING AT [16 INCHES (406 MM)] [400 MM] O.C FND OF SECTION 061053

SECTION 064000 - INTERIOR ARCHITECTURAL WOODWORK

B. FLUSH WOOD PANELING AND RUNNING TRIM.
B. FLUSH WOOD PANELING AND WAINSCOTS.
C. MELAMINE CABINETS.
D. SOLID-SURFACING-MATERIAL COUNTERTOPS.
E. CLOSET AND UTILITY SHELVING.
QUALITY ASSURANCE

E. CLOSET AND UTILITY SHELVING.
QUALITY ASSURANCE
A. QUALITY STANDARD: AWI.
MATERIALS
A. WOOD PRODUCTS: COMPLY WITH THE FOLLOWING:
1. HARDBOARD: AHA A135.4, MADE WITH BINDER CONTAINING NO UREA FORMALDEHYDE.
2. MEDIUM-DENSITY FIBERBOARD: ANSI A208.2, GRADE 130, MADE WITH BINDER CONTAINING NO UREA FORMALDEHYDE.
3. MOISTURE RESISTANT MEDIUM-DENSITY FIBERBOARD: ANSI A208.2, GRADE MD, MRSO, MADE WITH BINDER CONTAINING NO UREA FORMALDEHYDE.
4. STRAW-BASED PARTICLEBOARD: ANSI A208.1, GRADE M-2, EXCEPT FOR DENSITY. MADE WITH ADHESIVE CONTAINING NO

EXCEPT FOR DENSITY, MADE WITH ADHESIVE CONTAINING NO

UREA FORMALDEHYDE.
SOFTWOOD PLYWOOD: DOC PS 1
VENEER-FACED PANEL PRODUCTS (HARDWOOD PLYWOOD):
HPVA HP-1, MADE WITH ADHESIVE CONTAINING NO UREA

ADHESIVES, GENERAL: DO NOT USE ADHESIVES THAT CONTAIN

VOC LIMITS FOR INSTALLATION ADHESIVES AND GLUES: USE VOC LIMITS FOR INSTALLATION ADHESIVES AND GLUES! USE INSTALLATION ADHESIVES THAT COMPLY WITH THE FOLLOWING LIMITS FOR VOC CONTENT WHEN CALCULATED ACCORDING TO 40 CFR 59, SUBPART D (EPA METHOD 24):

WOOD GLUES: 30 G/L. PANEL ADHESIVE: 50 G/L

MULTIPURPOSE CONSTRUCTION ADHESIVE: 70 G/L 4. CONTACT ADHESIVE: 80 G/L.
a. SPECIAL PURPOSE: 250 G/L
CLOSET AND UTILITY SHELVING:

GRADE: ECONOMY.
SHELF MATERIAL: 3/4 INCH (19 MM) THERMOSET DECORATIVE
PANEL WITH PVC OR POLYESTER EDGE BANDING.
CLEATS: 3/4 INCH (19 MM) PANEL PRODUCT.

SHOP FINISHING:

1. GRADE: SAME GRADE AS WOODWORK.

2. EXTENT: ALL WOODWORK SHOP FINISHED.

2. EXTENT: ALL WOODWORK SHUP FINISHED.

NSTALLATION
A. SCRIBE AND CUT MILLWORK TO FIT ADJOINING WORK, REFINISH CUT SURFACES, AND REPAIR DAMAGED FINISH AT CUTS.

B. ANCHOR MILLWORK TO ANCHORS OR BLOCKING BUILT IN OR DIRECTLY ATTACHED TO SUBSTRATES. SECURE WITH COUNTERSUNK CONCEALED FASTENERS AND BLIND NAILING AS REQUIRED FOR COMPLETE INSTALLATION. USE FINE FINISHING NAILS OR FINISHING SCREWS FOR EXPOSED FASTENING, COUNTERSUNK AND FILLED FLUSH WITH MILLWORK AND MATCHING FINAL FINISH IF TRANSPARENT FINISH IS INDICATED.

IS INDICATED. CABINETS: INSTALL WITHOUT DISTORTION SO DOORS AND DRAWERS FIT OPENINGS PROPERLY AND ARE ACCURATELY ALIGNED. ADJUST OPENINGS PROPERLY AND ARE ACCORATELY ALIGNED. ADJUST HARDWARE TO CENTER DOORS AND DRAWERS IN OPENINGS AND TO PROVIDE UNENCUMBERED OPERATION. COMPLETE INSTALLATION OF HARDWARE AND ACCESSORY ITEMS AS INDICATED.

INSTALL CABINETS WITH NO MORE THAN 1/8 INCH IN 96 INCH (3 MM IN 2400 MM) SAG, BOW, OR OTHER VARIATION FROM A STRAIGHT LINE.
COUNTERTOPS: ANCHOR SECURELY BY SCREWING THROUGH CORNER

BLOCKS OF BASE CABINETS OR OTHER SUPPORTS INTO UNDERSIDE OF

ALIGN ADJACENT SOLID-SURFACING-MATERIAL COUNTERTOPS ALIGN ADJACENT SOLID-SURFACING-MATERIAL COUNTERTOPS
AND FORM SEAMS TO COMPLY WITH MANUFACTURES WRITTEN
RECOMMENDATIONS USING ADHESIVE IN COLOR TO MATCH
COUNTERTOP. CAREFULLY DRESS JOINTS SMOOTH, REMOVE
SURFACE SCRATCHES, AND CLEAN ENTIRE SURFACE.
INSTALL COUNTERTOPS WITH NO MORE THAN 1/8 INCH IN 96 INCH
(3 MM IN 2400 MM) SAG, BOW, OR OTHER VARIATION FROM A

STRAIGHT LINE. ' SECURE COVED BACKSPLASHES TO TOPS PER MANUFACTURES

FABRICATION MANUAL AND TO WALLS WITH ADHESIVE.
CALK SPACE BETWEEN BACKSPLASH AND WALL WITH SEALANT
SPECIFIED IN DIVISION 7 SECTION "JOINT SEALANTS."

THERMAL AND MOISTURE PROTECTION

SECTION 07841 - THROUGH-PENETRATION FIRESTOP SYSTEMS

PRODUCT DATA: FOR EACH TYPE OF PRODUCT INDICATED. QUALITY ASSURANCE INSTALLER QUALIFICATIONS: AN FM GLOBAL-APPROVED FIRESTOP

CONTRACTOR OR A UL-QUALIFIED FIRESTOP CONTRACTOR.
FIRE-TEST-RESPONSE CHARACTERISTICS: TESTED PER ASTM E 814 BY
QUALIFIED TESTING AND INSPECTING AGENCY. PENETRATION FIRESTOPPING
A. PENETRATIONS IN FIRE-RESISTANCE-RATED WALLS: F-RATINGS PER

PENETRATIONS IN FIRE-RESISTANCE-RATED WALLS: F-RATINGS PER ASTM & 814 OR UL 1479.
PENETRATIONS IN HORIZONTAL ASSEMBLIES: F- AND T-RATINGS PER ASTM & 814 OR UL 1479:
PENETRATIONS IN SMOKE BARRIERS: L-RATINGS PER UL 1479.
VOC CONTENT OF INTERIOR SEALANTS: PROVIDE INTERIOR SEALANTS AND SEALANT FINIMERS THAT COMPLY WITH THE FOLLOWING LIMITS FOR VOC CONTENT WHEN CALCULATED ACCORDING TO 40 CFR 59, SUBPART D (EPA METHOD 24):

1. SEALANT SEALANT SEALANTS (25 OG/L).
2. SEALANT PRIMERS FOR NONPOROUS SUBSTRATES: 250 G/L.
3. SEALANT PRIMERS FOR POROUS SUBSTRATES: 775 G/L.
LAUTION

INSTALLATION
A. IDENTIFICATION: PREPRINTED METAL OR PLASTIC LABELS, PERMANENTLY ATTACHED.
FIELD OUALITY CONTROL.
A. INSPECTION OF INSTALLED FIRESTOP SYSTEMS: BY OWNER-ENGAGED AGENCY ACCORDING TO ASTME 2174 REQUIREMENTS.

END OF SECTION 07841

SECTION 078446 - FIRE-RESISTIVE JOINT SYSTEMS

RY
FIRE-RESISTIVE JOINT SYSTEMS FOR THE FOLLOWING:
1. JOINTS IN OR BETWEEN FIRE-RESISTANCE-RATED CONSTRUCTIONS.
2. JOINTS AT EXTERIOR CURTAIN-WALL/FLOOR INTERSECTIONS.
3. JOINTS IN SMOKE BARRIERS.

PERFORMANCE REQUIREMENTS RMANCE REQUIREMENTS
FIRE-RESISTANCE RATINGS OF JOINT SYSTEMS IN AND BETWEEN FIRERESISTANCE-RATED CONSTRUCTIONS: EQUALING OR EXCEEDING THE
FIRE-RESISTANCE RATINGS OF CONSTRUCTION THAT THEY JOIN, [AND WITH
MOVEMENT CAPABILITIES INDICATED) AS DETERMINED BY UL 2079.

PRODUCT DATA: FOR EACH TYPE OF PRODUCT INDICATED.

QUALITY ASSURANCE
A. FIRE-TEST-RESPONSE CHARACTERISTICS: TESTED BY QUALIFIED TESTING

A. FIRE-1EST-RESPONSE CHARACTERISTICS: TESTED BY QUALIFIED TESTING
AND INSPECTING AGENCY.

FIRE-RESISTIVE JOINT SYSTEMS

A. DESIGNATION SYSTEM FOR JOINTS IN OR BETWEEN FIRE-RESISTANCE-RATED
CONSTRUCTIONS: ALPHANUMERIC SYSTEMS LISTED IN UL'S 'FIRE
RESISTANCE DIRECTORY' UNDER PRODUCT CATEGORY XHBN.

B. JOINTS IN OR BETWEEN FIRE-RESISTANCE-RATED CONSTRUCTION: EQUAL TO
OR EXCEEDING THE FIRE-RESISTANCE RATING OF CONSTRUCTION THEY WILL
ICINI.

OR EXCEEDING THE FIRE-RESISTANCE RATING OF CONSTRUCTION THEY WILL JOIN.

JOINTS AT EXTERIOR CURTAIN-WALL/FLOOR INTERSECTIONS: EQUAL TO OR EXCEEDING THE FIRE-RESISTANCE RATING OF THE FLOOR ASSEMBLY.

JOINTS IN SMOKE BARRIERS:

1. IN LEARTING: NOT EXCEEDING 5.0 CFMFT (0.00775 CU. M/S X M) OF JOINT AT 0.30 INCH WG (74.7 PA) AT BOTH AMBIENT AND ELEVATED TEMPERATURES.

EXPOSED FIRE-RESISTIVE JOINT SYSTEMS: PROVIDE PRODUCTS WITH FLAME-SPREAD AND SMOKE-DEVELOPED INDEXES OF LESS THAN 25 AND 450, RESPECTIVELY, AS DETERMINED PER ASTM E 84.

VOC CONTENT: FIRE-RESISTIVE JOINT SYSTEM SEALANTS SHALL COMPLY WITH THE FOLLOWING LIMITS FOR VOC CONTENT WHEN CALCULATED ACCORDING TO 40 CFR 9. SUBPART 10 (FPA METHOD 24):

1. ARCHITECTURAL SEALANTS: 250 G/L.

2. SEALANT PRIMERS FOR NONPOROUS SUBSTRATES: 250 G/L.

ARCHITECTURAL SEALANTS: 250 G/L.
 SEALANT PRIMERS FOR NONPOROUS SUBSTRATES: 250 G/L.
 SEALANT PRIMERS FOR POROUS SUBSTRATES: 775 G/L.
 ACCESSORIES: FORMING MATERIALS AND OTHER COMPONENTS NEEDED

TO INSTALL FILL MATERIALS AND MAINTAIN RATINGS REQUIRED

THERMAL AND MOISTURE PROTECTION (CONT)

SECTION 079200 - JOINT SEALANTS

IALS
VOC CONTENT OF INTERIOR SEALANTS: PROVIDE INTERIOR SEALANTS AND
SEALANT PRIMERS THAT COMPLY WITH THE FOLLOWING LIMITS FOR VOC
CONTENT WHEN CALCULATED ACCORDING TO 40 CFR 59, SUBPART D

CONTENT WHEN CALCULATED ALCORDING TO 40 CFR 39, SUBPART D (EPA METHOD 24):

1. SEALANTS: 250 G/L.

2. SEALANT PRIMERS FOR NONPOROUS SUBSTRATES: 250 G/L.

3. SEALANT PRIMERS FOR POROUS SUBSTRATES: 775 G/L.

SUITABILITY FOR CONTACT WITH FOOD: WHERE SEALANTS ARE INDICATED FOR JOINTS THAT WILL COME IN REPEATED CONTACT WITH FOOD, PROVIDE PRODUCTS THAT COMPLY WITH 21 CFR 177.2600.

ELASTOMERIC JOINT SEALANTS: LIQUID APPLIED, CHEMICALLY CURING; ASTM (C. 290.)

ASTM C 920.

1. MULTICOMPONENT NONSAG NEUTRAL-CURING SILICONE SEALANT

ES-1.
SINGLE-COMPONENT MILDEW-RESISTANT NEUTRAL-CURING SILICONE SEALANT ES-2.
SINGLE-COMPONENT MILDEW-RESISTANT ACID-CURING SILICONE SEALANT ES-3.

SEALANT ES-3.

4. SINGLE-COMPONENT MILDEW-RESISTANT ACID-CURING RTV SILICONE SEALANT ES-4.

5. MULTICOMPONENT NONSAG POLYUREA SEALANT ES-5.

6. MULTICOMPONENT NONSAG POLYUREA FILLER ES-6.

LATEX SEALANT LS-1: COMPLY WITH ASTM C 834, TYPE P, GRADE NF. JOINT-SEALANT BACKING:

JOINT-SEALANT SCHEDULE SEALANT SCHEDULE
JOINT-SEALANT APPLICATION JS-1: EXTERIOR HORIZONTAL NONTRAFFIC AND TRAFFIC ISOLATION AND CONTRACTION JOINTS IN CAST-IN-PLACE CONCRETE SLABS

CONCRETE SLABS.

JOINT SEALANT: ES-5.

JOINT-SEALANT APPLICATION JS-2: EXTERIOR PERIMETER JOINTS BETWEEN WALL AND FRAMES OF DOORS AND WINDOWS.

VALL AND FRANCES OF DOUGN AND WINDOWS

JOINT SEALANT ES-1.

JOINTS IN HORIZONTAL TRAFFIC SURFACES OF BRICK PAVERS, CERAMIC

TILE, STONE PAVING UNITS, CONCRETE TILE.

JOINT SHANT SEALANT MULTICOMPONENT POURABLE POLYSULFIDE

SEALANT.
JOINT-SEALANT COLOR: AS SELECTED BY ARCHITECT FROM

MANUFACTURER'S FULL RANGE.
JOINT-SEALANT APPLICATION JS-4: INTERIOR PERIMETER JOINTS OF EXTERIOR OPENINGS.

1. JOINT SEALANT: ES-3.
JOINT-SEALANT APPLICATION JS-5: INTERIOR CERAMIC TILE EXPANSION,
CONTROL, CONTRACTION, AND ISOLATION JOINTS IN HORIZONTAL TRAFFIC

JOINT-SEALANT COLOR: I RANSLUCENI.

JOINT-SEALANT APPLICATION JS-7: VERTICAL JOINTS ON EXPOSED SURFACES OF INTERIOR PARTITIONS.

JOINT SEALANT: ES-3.

JOINT-SEALANT APPLICATION JS-8: PERIMETER JOINTS BETWEEN INTERIOR WALL SURFACES AND FRAMES OF INTERIOR DOORS, WINDOWS.

JOINT SEALANT: ES-3. JOINT-SEALANT APPLICATION JS-9: HVAC JOINTS.

JOINT SEALANT: ES-2. JOINT-SEALANT COLOR: ALUMINUM. JOINT-SEALANT APPLICATION JS-10: NON-POROUS MATERIAL TO JOINT-SEALANT APPLICATION 35-10. NO NON-POROUS MATERIAL. 1. JOINT SEALANT: ES-4. 2. JOINT-SEALANT COLOR: CLEAR.

END OF SECTION 079200

DOORS AND WINDOWS

SECTION 081416 - FLUSH WOOD DOORS

PRODUCT DATA: FOR EACH TYPE OF DOOR INDICATED. INCLUDE DETAILS

OF CORE AND EDGE CONSTRUCTION AND TRIM FOR OPENINGS. SHOP DRAWINGS: INDICATE LOCATION, SIZE, AND HAND OF EACH DOOR; ELEVATION OF EACH KIND OF DOOR; CONSTRUCTION DETAILS NOT COVERED IN PRODUCT DATA; LOCATION AND EXTENT OF HARDWARE

BLOCKING; AND OTHER PERTINENT DATA. 1. INDICATE DIMENSIONS AND LOCATIONS OF MORTISES AND HOLES FOR HARDWARE.
INDICATE DIMENSIONS AND LOCATIONS OF CUTOUTS

INDICATE REQUIREMENTS FOR VENEER MATCHING. INDICATE DOORS TO BE FACTORY FINISHED AND FINISH

4. INDICATE DOORS TO BE FACTORY PINISHED AND FINISH
REQUIREMENTS.
S. INDICATE POORS TO BE FACTORY PINISHED AND FINISH
REQUIREMENTS.
C. WARRANTY: SAMPLE OF SPECIAL WARRANTY.
QUALITY ASSURANCE
A. QUALITY STANDARD: AWI.
1. AWI QUALITY CERTIFICATION LABELS OR AN AWI LETTER OF
LICENSING FOR DOORS.
2. WI-CERTIFIED COMPULANCE CERTIFICATE FOR DOORS AND
INSTALLATION.
B. FIRE-RATED WOOD DOORS: POSITIVE PRESSURE TESTING.
DOOR CONSTRUCTION, GENERAL
A. LOW-EMITTING MATERIALS: MADE WITH ADHESIVES AND COMPOSITE WOOD
PRODUCTS THAT DO HAVE NO ADDED UREA FORMALDEHYDE.
B. WIDMA 1.S.1-AP PERFORMANCE GRADE: HEAVY DUTY UNLESS OTHERWISE
INDICATED.
VENERRED-FACED DOORS FOR TRANSPARENT FINISH

VENEERED-FACED DOORS FOR TRANSPARENT FINISH

PRIMING/FINISHING SHOP PRIMING:

DOORS FOR TRANSPARENT FINISH: STAIN AND FIRST COAT OF

FACTORY FINISHING: ALL DOORS.

SECTION 08331 - OVERHEAD COILING DOORS

STIBMITTALS

I ALS
PRODUCT DATA: FOR EACH TYPE AND SIZE OF OVERHEAD COILING DOOR
AND ACCESSORY. INCLUDE THE FOLLOWING:
SHOP DRAWINGS: FOR EACH INSTALLATION AND FOR SPECIAL COMPONENTS

NOT DIMENSIONED OR DETAILED IN MANUFACTURER'S PRODUCT DATA

DETAIL EQUIPMENT ASSEMBLIES AND INDICATE DIMENSIONS,

CONNECTION.

SAMPLES FOR INITIAL SELECTION: MANUFACTURER'S FINISH CHARTS
SHOWING FULL RANGE OF COLORS AND TEXTURES AVAILABLE FOR UNITS

SELECTION.
SAMPLES FOR VERIFICATION: FOR EACH TYPE OF EXPOSED FINISH

PERFORMANCE REQUIREMENTS

RMANCE REQUIREMENTS
OPERATION-CYCLE REQUIREMENTS: PROVIDE OVERHEAD COILING GRILLE
COMPONENTS AND OPERATORS CAPABLE OF OPERATING FOR NOT LESS
THAN 50,000 CYCLES AND FOR 25 CYCLES PER DAY. DOOR ASSEMBLY ISSEMBLY
GENERAL: FABRICATE OVERHEAD COILING GRILLE CURTAIN CONSISTING OF

GENERAL: FABRICATE OVERHEAD COLLING GRILLE CURTAIN CONSISTING OF A NETWORK OF 5/16 INCH (8 MM) MINIMUM DIAMETER HORIZONTAL RODS, OR RODS COVERED WITH TUBE SPACERS, SPACED AS INDICATED. INTERCONNECT RODS BY VERTICAL LINKS APPROXIMATELY 5/6 INCH (16 MM) WIDE, SPACED AS INDICATED AND ROTATING ON RODS.

1. SPACED AS INDICATED AND ROTATING ON RODS.
2. SPACE LINKS APPROXIMATELY 9 INCHES (38 MM) O.C.
2. SPACE LINKS APPROXIMATELY 9 INCHES (228 MM) APART IN A STRAIGHT IN-LINE PATTERN.
3. ALUMINUM GRILLE CURTAIN: ASTM B 221 (ASTM B 221 M), ALLOY AND TEMPER RECOMMENDED BY ALUMINUM PRODUCER AND FINISHER FOR TYPE OF USE AND FINISH INDICATED.

HOOD: ALUMINUM.

1.5 INSTALLATION
A. FACTORY-AUTHORIZED REPRESENTATIVE TO [PERFORM STARTUP SERVICE AND TESTING] [AND] [TRAIN OWNER'S PERSONNEL].

END OF SECTION 08331

DOORS AND WINDOWS (CONTINUED)

SECTION 08345 - DOUBLE ACTING SWING DOORS

SUMMARY

SECTION INCLUDES SOLID-CORE DOUBLE ACTING SWING DOORS WITH PLASTIC LAMINATE FACES.

TTALS
PRODUCT DATA: FOR EACH TYPE OF PRODUCT INDICATED. INCLUDE
CONSTRUCTION DETAILS, MATERIAL DESCRIPTIONS, CORE
DESCRIPTIONS, FIRE-RESISTANCE RATING, TEMPERATURE-RISE

DESCRIPTIONS, FIRE-RESISTANCE RATING, TEMPERATURE-RISE
RATINGS, AND FINISHES.
SHOP DRAWINGS: INCLUDE THE FOLLOWING:
1. ELEVATIONS OF FACH DOOR DESIGN.
2. DETAILS OF FORCES, INCLUDING VERTICAL AND HORIZONTAL
EOG DETAILS AND METAL THICKNESSES.
3. FRAME DETAILS FOR FACH FRAME TYPE, INCLUDING
DIMENSIONED PROFILES AND METAL THICKNESSES.
4. LOCATIONS OF REINFORCEMENT AND PREPARATIONS FOR
MADDWADE

HARDWARE.

5. DETAILS OF ACCESSORIES.
6. DETAILS OF MOLDINGS, REMOVABLE STOPS, AND GLAZING.
STANDARD DOUBLE ACTING SWINIG DOORS

A. GENERAL: PROVIDE DOORS OF DESIGN INDICATED, NOT LESS THAN
THICKNESS INDICATED; FABRICATED WITH SMOOTH SURFACES,
WITHOUT VISIBLE JOINTS OR SEAMS ON EXPOSED FACES UNLESS
OTHERWISE INDICATED. COMPLY WITH ANSI/SDI A250.8.

1. DESIGN: AS INDICATED.
B. CORE CONSTRUCTION: 3/4 INCH (19 MM) EXTERIOR GRADE SOLID WOOD
CORE MADE WITH ADHESIVES AND COMPOSITE WOOD PRODUCTS THAT
DO NOT CONTAIN UREA FORMALDEHYDE.

1. VERTICAL EDGES FOR DOUBLE-ACTING DOORS: ROUND
VERTICAL EDGES FOR DOUBLE-ACTING DOORS: ROUND
VERTICAL EDGES FOR DOUBLE-ACTING DOORS:

VERTICAL EDGES FUR DOUBLE-ACTING DOORS: ROUND
VERTICAL EDGES WITH 2-1/8 INCH (54 MM) RADIUS.
TOP AND BOTTOM EDGES: CLOSED WITH FLUSH OR INVERTED
0.042 INCH (1.0 MM) THICK, END CLOSURES OR CHANNELS OF

0.042 INCH (1.0 MM) THICK, END CLOSURES OR CHANNELS OF SAME MATERIAL AS FACE SHEETS.

3. TOLERANCES: COMPLY WITH SDI 117, "MANUFACTURING TOLERANCES FOR STANDARD STEEL DOORS AND FRAMES." INTERIOR DOORS: FACE SHEETS FABRICATED FROM DECORATIVE HIGH PRESSURE LAMINATE. PROVIDE DOORS COMPLYING WITH REQUIREMENTS INDICATED BELOW BY REFERENCING ANSI/SDI A250.8 FOR LEVEL AND MODEL AND ANSI/SDI A250.4 FOR PHYSICAL

FOR LEVEL AND MODEL AND ANSIADI A250.4 FOR PHYSICAL PERFORMANCE LEVEL:

1. LEVEL 1 AND PHYSICAL PERFORMANCE LEVEL C (STANDARD DUTY).

a. WIDTH: AS INDICATED ON DRAWINGS.

HARDWARE REINFORCEMENT: FABRICATE ACCORDING TO ANSISSDI A250.6 WITH REINFORCING PLATES OF 18 GAUGE STAINLESS OFTEE:

STEEL

FABRICATE CONCEALED STIFFENERS AND HARDWARE REINFORCEMENT FROM EITHER COLD- OR HOT-ROLLED STEEL SHEET.

STOPS AND MOLDINGS

A DOLDINGS FOR GLAZED LITES IN DOORS:
MINIMUM 0.032 INCH (10.8 MM) THICK.

B. LOOSE STOPS FOR GLAZED LITES IN FRAMES:
MINIMUM 0.032 INCH (10.8 MM) THICK, FABRICATED FROM SAME MATERIAL AS FRAMES IN WHICH THEY ARE INSTALLED.

STEEL FINISHEE.

A. PRIME FINISH: APPLY MANUFACTURER'S STANDARD PRIMER

PRIME FINISH: APPLY MANUFACT URER'S ST ANDARD PRIMER
MMEDIATELY AFTER CLEANING AND PRETREATING.

1. SHOP PRIMER: MANUFACTURER'S STANDARD, FAST-CURING,
LEAD-AND CHROMATE-FREE PRIMER COMPLYING WITH
ANSI/SDI A250.10 ACCEPTANCE CRITERIA; RECOMMENDED BY
PRIMER MANUFACTURER FOR SUBSTRATE; COMPATIBLE WITH SUBSTRATE AND FIELD-APPLIED COATINGS DESPITE

PROLONGED EXPOSURE FACTORY-APPLIED PAINT FINISH: MANUFACTURER'S STANDARD, COMPLYING WITH ANSI/SDI A250.3 FOR PERFORMANCE AND

ACCEPTANCE CRITERIA. COLOR AND GLOSS: AS INDICATED BY MANUFACTURER'S DESIGNATIONS.

FINISHES

END OF SECTION 0921

SECTION 09216 - NON-LOAD-BEARING STEEL FRAMING

NON-LOAD-BEARING STEEL FRAMING MEMBERS FOR INTERIOR FRAMING SYSTEMS.

MATERIALS STEEL FRAMING FOR FRAMED ASSEMBLIES:

FRAMING MEMBERS, GENERAL: COMPLY WITH ASTM C 754 FOR CONDITIONS INDICATED.

1. STEEL SHEET COMPONENTS: COMPLY WITH ASTM C 645 STEEL SHEET COMPONENTS: COMPLY WITH ASTM C 649
REQUIREMENTS FOR METAL, UNLESS OTHERWISE INDICATED.
PROTECTIVE COATING: COATING WITH EQUIVALENT CORROSION
RESISTANCE OF ASTM A 653/A 653M, G40 (Z120), HOT-DIP

GALVANIZED, UNLESS OTHERWISE INDICATED.

STEEL FRAMING FOR FRAMED ASSEMBLIES

A. SALVAGED MATERIAL: USE SALVAGED FRAMING MATERIALS WHENEVER

SALVAGED MATERIAL: USE SALVAGED FRAMING MATERIALS WHENEVER AVAILABLE.

STEEL STUDS AND RUNNERS: ASTM C 645.

1. MINIMUM BASE-METAL THICKNESS: 0.033 INCH (0.84 MM) UNLESS OTHERWISE INDICATED ON DRAWINGS.

2. DEFTH: AS INDICATED ON DRAWINGS.

DIMPLED STEEL STUDS AND RUNNERS:

1. MINIMUM BASE-METAL THICKNESS: 0.025 INCH (0.64 MM).

2. DEFTH: AS INDICATED ON DRAWINGS.

SLIP-TYPE HEAD JOINTS: WHERE INDICATED, PROVIDE ONE OF THE FOLL OWING.

SLIP-TYPE HEAD JOINTS: WHERE INDICATED, PROVIDE ONE OF THE FOLLOWING:

1. SINGLE LONG-LEG RUNNER SYSTEM: ASTM C 645 TOP RUNNER WITH 2 INCH (60.8 MM) DEEP FLANGES IN THICKNESS NOT LESS THAN INDICATED FOR STUDS, INSTALLED WITH STUDS FRICTION FIT INTO TOP RUNNER AND WITH CONTINUOUS BRIDDING LOCATED WITHIN 12 INCHES (305 MM) OF THE TOP OF STUDS TO PROVIDE LATERAL BRACING.

2. DOUBLE-RUNNER SYSTEM: ASTM C 645 TOP RUNNERS, INSIGN CONTINUES WITH 2 INCH (50.8 MM) DEEP FLANGES IN THICKNESS NOT LESS THAN INDICATED FOR STUDS AND FASTENED TO STUDS, AND OF THE DILINIER SYSTEM SYSTEM IN STUDS AND ASSENCE TO STUDS, AND

OLITER RUNNER SIZED TO ERICTION FIT INSIDE RUNNER DEFLECTION TRACK: STEEL SHEET TOP RUNNER MANUFACTURED

OUTER RUNNER SIZED TO FRICTION FIT INSIDE RUNNER.

3. DEFLECTION TRACK: STEEL SHEET TOP RUNNER MANUFACTURED TO PREVENT CRACKING OF FINISHES APPLIED TO INTERIOR PARTITION FRAMING RESULTING FROM DEFLECTION OF STRUCTURE ABOVE; IN THICKNESS NOT LESS THAN INDICATED FOR STUDS AND IN WIDTH TO ACCOMMODATE DEPTH OF STUDS.

COLD-ROLLED CHANNEL BRIDGING: 0.0638 INCH (1.37 MM) BARE-STEEL THICKNESS, WITH MINIMIM 1/2; INCH (1.27 MM) WIDE FLANGES.

1. DEPTH: 1-1/2; INCHES (38.1 MM),
2. CLEP ANGLE: NOT LESS THAN 1-1/2 BY 1-1/2; INCHES (38.1 BY 38.1 MM), 0.068 INCH (1.73 MM) THICK, GALVANIZED STEEL.

HAT-SHAPED, RIGID FURRING CHANNELS: ASTM C 645.

1. MINIMUM BASE METAL THICKNESS: ASTM C 645.

2. DEPTH: AS INDICATED ON DRAWINGS.

2. DEPTH: AS INDICATED ON DRAWINGS.

COLD-ROLLED FURRING CHANNELS: 0.0538 INCH (1.37 MM) BARE-STEEL THICKNESS, WITH MINIMUM 1/2; INCH (1.27 MM) WIDE FLANGES.

1. DEPTH: AS INDICATED ON DRAWINGS.

2. FURRING GHANNELS: 0.0538 INCH (1.37 MM) BARE-STEEL THICKNESS, WITH MINIMUM 1/2; INCH (1.27 MM) WIDE FLANGES.

3. TIE WIRE: ASTM A 641/A 641/M, CLASS 1 ZINC COATING, SOFT TEMPER, 0.0625 INCH (1.59 MM) DIAMETER WIRE, OR DOUBLE TEMPER, 0.0625 INCH (1.59 MM) DIAMETER WIRE, OR DOUBLE TEMPER, 0.0625 INCH (1.59 MM) DIAMETER WIRE, OR DOUBLE Z-SHAPED FURRING: WITH SLOTTED OR NONSLOTTED WEB, FACE FLANGE OF 1-1/4 INCHES (3.5 MM), WALL ATTACHMENT FLANGE OF 7/8 INCH (2.2 MM), MINIMUM BARE-METAL THICKNESS OF 0.0179 INCH (0.45 MM), AND DEPTH REQUIRED TO FIT INSULATION THICKNESS INDICATED.

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STORE #: PROJECT #: 14516-022 CONCEPT NCS PAI ETTE HERITAGE ISSUE DATE 10.17.13

FED® AP PRODUCTION DESIGNER: C. ALINOVICH, NORR

CHECKED BY SHEET TITLE

SCALE:

DESIGN MANAGER:

DESIGN SPECIFICATIONS

S. RYCHLIK

K GORIN NORR

G-0011

CORE: PARTICLEBOARD.
 CONSTRUCTION: FIVE OR SEVEN PLIES, BONDED.

DOORS FOR OPAQUE FINISH: ONE COAT OF WOOD PRIMER.

INCLUDE PLANS, ELEVATIONS, SECTIONS, DETAILS, AND ATTACHMENTS TO

WEIGHTS, LOADS, REQUIRED CLEARANCES, METHOD OF FIELD ASSEMBLY, COMPONENTS, AND LOCATION AND SIZE OF EACH FIELD

WITH FACTORY-APPLIED FINISHES.

1. INCLUDE SIMILAR SAMPLES OF ACCESSORIES INVOLVING COLOR

SAMPLES FOR VERIFICATION: FOR EACH TYPE OF EXPOSED FINISH REQUIRED, PREPARED ON SAMPLES OF SIZE INDICATED BELOW.

1. CURTAIN SLATS: 12 INCHES (305 MM) LONG.

2. BOTTOM BAR: 6 INCHES (150 MM) LONG.

3. GUIDES: 6 INCHES (150 MM) LONG.

4. BRACKETS: 6 INCHES (150 MM) SOUARE.

5. DELEGATED-DESIGN SUBMITTAL: FOR OVERHEAD COILING DOORS INDICATED TO COMPLY WITH PERFORMANCE REQUIREMENTS AND DESIGN CRITERIA, INCLUDING ANALYSIS DATA SIGNED AND SEALED BY THE QUALIFIED PROFESSIONAL ENGINEER RESPONSIBLE FOR THEIR PREPARATION.

1. DETAIL FABRICATION AND ASSEMBLY OF SEISMIC RESTRAINTS.

2. SUMMARY OF FORCES AND LOADS ON WALLS AND JAMS.

QUALIFICATION DATA: FOR QUALIFIED INSTALLER.

SEISMIC QUALIFICATION CERTIFICATES: FOR OVERHEAD COILING DOORS, ACCESSORIES, AND COMPONENTS, FROM MANUFACTURER.

MAINTENANCE DATA: FOR OVERHEAD COILING DOORS TO INCLUDE IN MAINTENANCE MANUALS.

MANUAL DOOR OPERATOR.

1.2 SUBMITTALS

TTALS
PRODUCT DATA: FOR EACH TYPE OF PRODUCT INDICATED.
SAMPLES: FOR THE FOLLOWING PRODUCTS:

1. TEXTURED FINISHES: MANUFACTURER'S STANDARD SIZE FOR EACH
TEXTURED FINISH INDICATED AND ON SAME BACKING INDICATED
FOR WORK.

RIALS
INTERIOR GYPSUM BOARD:

1. GENERAL: COMPLYING WITH ASTM C 36/C 36M OR
ASTM C 1396/C 1396M, AS APPLICABLE TO TYPE OF GYPSUM BOARD
INDICATED AND WHICHEVER IS MORE STRINGENT.

a. MUST BE CERTIFIED AS LOW EMITTING, CERTIFICATION
MUST BE BASED UPON THE CALIFORNIA DEPARTMENT OF
HEALTH SERVICES "STANDARD PRACTICE FOR THE
TESTING OF VOLATILE ORGANIC EMISSIONS FROM
VARIOUS SOURCES USING SMALL-SCALE ENVIRONMENTAL
CHAMBERS", INCLUDING 2004 ADDENDA OR A
JURISDICTIONALLY RECOGNIZED STANDARD USING
VALENT TESTING METHODOLOGIES AND VOC THRESHOLDS.

2. TYPE X:

TYPE X

THICKNESS: 5/8 INCH (15.9 MM).

MOISTURE- AND MOLD-RESISTANT TYPE: WITH MOISTURE- AND MOLD-RESISTANT CORE AND SURFACES.

CORE: 5/8 INCH (15.9 MM), TYPE X. LONG EDGES: TAPERED. MOLD RESISTANCE: ASTM D 3273, SCORE OF 10 AS RATED ACCORDING TO ASTM D 3274.

TILE-BACKING PANELS:

GLASS-MAT, WATER-RESISTANT BACKING BOARD:

GLASS-MAT, WATER-RESISTANT BACKING BOARD:
ASTM C 11780: HITM HANDIFACTURER'S STANDARD EDGES.

a. MUST BE CERTIFIED AS LOW EMITTING. CERTIFICATION
MUST BE BASED UPON THE CALIFORNIA DEPARTMENT OF
HEALTH SERVICES "STANDARD PRACTICE FOR THE
TESTING OF VOLATILE ORGANIC EMISSIONS FROM
VARIOUS SOURCES USING SMALL-SCALE ENVIRONMENTAL
CHAMBERS', INCLUDING 2004 ADDENDA OR A
JURISDICTIONALLY RECOGNIZED STANDARD I ISING JURISDICTIONALLY RECOGNIZED STANDARD USING EQUIVALENT TESTING METHODOLOGIES AND VOC

EQUIVALENT TESTING METHODOLOGIES AND VOC THRESHOLDS.
b. CORE: 5/8 INCH (15.9 MM), TYPE X.
c. MOLD RESISTANCE: ASTM D 3273, SCORE OF 10 AS RATED ACCORDING TO ASTM D 3274.
CEMENTITIOUS BACKER UNITS: ANSI A118.9 AND ASTM C 1288 OR 1325, WITH MANUFACTURER'S STANDARD EDGES.
a. THICKNESS: [1/4 INCH (6.4 MM)] [AS INDICATED].
b. MOLD RESISTANCE: ASTM D 3273, SCORE OF 10 AS RATED ACCORDING TO ASTM D 3274.

TRIM ACCESSORIES:
a. INTERIOR: CORNERBEAD.

END OF SECTION 092900

SECTION 093000 - CERAMIC TILE

ARY
PAVER, GLAZED, AND WALL TILE.
WATERPROOF MEMBRANE FOR THIN-SET TILE INSTALLATIONS.
METAL EDGE STRIPS INSTALLED AS PART OF TILE INSTALLATIONS.

QUALITY ASSURANCE
A. MOCKUPS FOR EACH FORM OF CONSTRUCTION. 1.3

OUALITY ASSUMANCE
A. MOCKUPS FOR EACH FORM OF CONSTRUCTION.
MATERIALS
A. GLAZED WALL TILE TRIM SHAPES: COVED BASE, BULLNOSE CAP.
B. THRESHOLDS: SATIN ANODIZED ALUMINUM THRESHOLDS AND TRANSITION STRIPS.

1. BEVEL EDGES AT 1:2 SLOPE, WITH LOWER EDGE OF BEVEL ALIGNED WITH ON PTO 1/16 INCH (1:5 MM) ABOVE ADJACENT FLOOR SURFACE. FINISH BEVEL TO MATCH TOP SURFACE OF THRESHOLD. LIMIT HEIGHT OF THRESHOLD TO 1/2 INCH (1:7 MM) OR LESS ABOVE ADJACENT FLOOR SURFACE.
C. MORTAR: LATEX-PORTLAND CEMENT
D. ELASTOMERIC SEALANTS: ONE-PART, MILDEW-RESISTANT SILICONE.
1. SEALANTS SHALL HAVE A VOC CONTENT OF [250]
Of OR LESS WHEN CALCULATED ACCORDING TO 40 CFR 59, SUBPART D (EPA METHOD 24).

FLOOR TILE INSTALLATION SCHEDULE
A. INTERIOR FLOORS ON CONCRETE: THIN-SET MORTAR.
1. TILE TYPE: UNGLAZED PAVER TILE.
2. MORTAR: LATEX-PORTLAND CEMENT MORTAR BOND COAT.
3. GROUT: POLYMER-MODIFIED UNSANDED 100%, SOLIDS EPOXY NON-SAGGING GROUT.

INTERIOR FLOORS ON [WATERPROOF] [CRACK-SUPPRESSION] MEMBRANE

OVER CONCRETE AND WOOD: THIN-SET MORTAR.

1. TILE TYPE: UNGLAZED PAVER TILE.

MORTAR: LATEX- PORTLAND CEMENT MORTAR BOND COAT GROUT: POLYMER-MODIFIED UNSANDED 100% SOLIDS EPOXY

NON-SAGGING GROUT. WALL TILE INSTALLATION SCHEDULE

LE INSTALLATION SCHEDULE INTERIOR WALLS OVER GLASS-MAT WATER-RESISTANT BACKER BOARD OR

INTERIOR WALLS OVER OLDSSIMM WITERARDS IAN D
CEMENTITIOUS BACKER UNITS: THIN-SET MORTAR
1. TILE TYPE: [GLAZED WALL] TILE.
2. MORTAR: LATEX-PORTLAND CEMENT MORTAR.
3. GROUT: POLYMER-MODIFIED UNSANDED GROUT

FINISHES (CONTINUED)

SECTION 095113 - ACOUSTICAL PANEL CEILINGS 1.1 SUMMARY

A. ACOUSTICAL PANELS AND EXPOSED SUSPENSION SYSTEMS. SUBMITTALS

PRODUCT DATA: FOR EACH TYPE OF PRODUCT INDICATED.

COORDINATION DRAWINGS: REFLECTED CEILING PLANS, DRAWN TO SCALE, ON WHICH THE FOLLOWING ITEMS ARE SHOWN AND COORDINATED WITH EACH OTHER, BASED ON INPUT FROM INSTALLERS OF THE ITEMS

IED: CEILING SUSPENSION SYSTEM MEMBERS. METHOD OF ATTACHING HANGERS TO BUILDING STRUCTURE. CEILING-MOUNTED ITEMS INCLUDING LIGHTING FIXTURES, DIFFUSERS, GRILLES, SPEAKERS, SPRINKLERS, ACCESS PANELS,

AND SPECIAL MOLDINGS.
SAMPLES FOR VERIFICATION: FOR EACH COMPONENT INDICATED AND FOR

EACH EXPOSED FINISH REQUIRED, PREPARED ON SAMPLES OF SIZE INDICATED BELOW:

1. ACOUSTICAL PANEL: SET OF FULL-SIZE SAMPLES OF EACH TYPE,

COLOR, PATTERN, AND TEXTURE.

EXPOSED SUSPENSION SYSTEM MEMBERS, MOLDINGS, AND TRIM:
SET OF 12 INCH (300 MM) LONG SAMPLES OF EACH TYPE, FINISH,

AND COLOR.

QUALIFICATION DATA: FOR TESTING AGENCY.

D. QUALIFICATION DATA: FOR TESTING AGENCY.
E. FIELD QUALITY-CONTROL TEST REPORTS.
F. PRODUCT TEST REPORTS: BASED ON EVALUATION OF COMPREHENSIVE TESTS PERFORMED BY A QUALIFIED TESTING AGENCY, FOR EACH ACOUSTICAL PANEL CEILING.
G. MAINTENANCE DATA: FOR FINISHES TO INCLUDE IN MAINTENANCE MANUALS.
QUALITY ASSURANCE
A. ACOUSTICAL PANEL QUALITY STANDARD: ASTM E 1264.
B. METAL SUSPENSION SYSTEM QUALITY STANDARD: ASTM C 635.

B. METAL SUSPENSION STSTEM QUALITY STRAINS
A ACOUSTICAL CEILING PANELS GENERAL: MUST BE CERTIFIED AS LOW
EMITTING, CERTIFICATION MUST BE BASED UPON THE CALIFORNIA
DEPARTMENT OF HEALTH SERVICES "STANDARD PRACTICE FOR THE
TESTING OF VOLATILE ORGANIC EMISSIONS FROM VARIOUS SOURCES USING
SMALL-SCALE ENVIRONMENTAL CHAMBERS", INCLUDING 2004 ADDENDA OR A
JURISDICTIONALLY RECOGNIZED STANDARD USING EQUIVALENT TESTING
METHODOLOGIES AND VOC THRESHOLDS.

B ACQUISTICAL CEILING PANELS WASHABLE

CLASSIFICATION: TYPE IV, MINERAL BASE WITH MEMBRANE-FACED OVERLAY: FORM 2, WATER FELTED: WITH VINYL OVERLAY ON FACE: PATTERN G (SMOOTH).

COLOR: AS INDICATED ON DRAWINGS.

HICKNESS: 5/8 INCH (15 MM). MODULAR SIZE: 24 BY 48 INCHES (610 BY 1220 MM).

4. MODULAR SIZE: 24 BY 48 INCHES (610 BY 1220 MM).
5. BROAD SPECTRUM ANTIMICROBIAL FUNGICIDE AND BACTERICIDE TREATMENT: PROVIDE ACOUSTICAL TILES TREATED WITH MANUFACTURER'S STANDARD ANTIMICROBIAL FORMULATION THAT INHIBITS FUNDIS, MOLD, MILDEW, AND GRAM-POSITIVE AND GRAM-REGATIVE BACTERIA AND SHOWING NO MOLD, MILDEW, OR BACTERIAL GROWTH WHEN TESTED ACCORDING TO ASTM D 3273 AND EVALUATED ACCORDING TO ASTM D 3274 OR ASTM G 21.

ACOUSTICAL CEILING PANELS TEXTURED:
1. CLASSIFICATION: TYPE III, MINERAL BASE WITH PAINTED FINISH; FORM 2, WATER FELTED; PATTERN E (LIGHTLY TEXTURED).
2. COLOR: AS INDICATED ON DRAWINGS.
3. THICKNESS: 36 INCH (15 MM).

2. COLOR: AS INDICATED ON DRAWINGS.
3. THICKNESS: 58 INCH (15 MM).
4. MODULAR SIZE: 24 BY 48 INCHES (610 BY 1220 MM).
5. BROAD SPECTRUM ANTIMICROBIAL FUNGICIDE AND BACTERICIDE TREATMENT: PROVIDE ACOUSTICAL TILES TREATED WITH MANUFACTURERS STANDARD ANTIMICROBIAL FORMULATION THAT INHIBITS FUNGUS, MOLD, MILDEW, AND GRAM-POSITIVE AND GRAM-POSITIVE BACTERIA AND SHOWINS ON MOLD, MILDEW, OR BACTERIAL GROWTH WHEN TESTED ACCORDING TO ASTM D 3273 AND EVALUATED ACCORDING TO ASTM D 3274 OR ASTM G 21.
4COUSTICAL CELLING PANELS PERFORATED:
1. CLASSIFICATION: TYPE III, MINERAL BASE WITH PAINTED FINISH; FORM 2, WATER FELTED; PATTERN CE (PERFORATED, SMALL HOLES AND LIGHTLY TEXTURED).
2. COLOR: AS INDICATED ON DRAWINGS.
3. THICKNESS: 34 INCH (15 MM).

THICKNESS: 3/4 INCH (15 MM)

THICKNESS: 3/4 INCH (15 MM).
MODILAR SIZE: 24 BY 48 INCHES (610 BY 1220 MM).
BROAD SPECTRUM ANTIMICROBIAL FUNCICIDE AND BACTERICIDE
TREATMENT: PROVIDE ACOUSTICAL TILES TREATED WITH
MANUFACTURER'S STANDARD ANTIMICROBIAL FORMULATION THAT INHIBITS FUNGUS, MOLD, MILDEW, AND GRAM-POSITIVE AND GRAM-REGATIVE BACTERIA AND SHOWING NO MOLD, MILDEW, OR BACTERIAL GROWTH WHEN TESTED ACCORDING TO ASTM D 3273 AND EVALUATED ACCORDING TO ASTM D 3274 OR ASTM G 21.

METAL SUSPENSION SYSTEMS:

1. WIDE-FACE, CAPPED, DOUBLE-WEB STEEL: INTERMEDIATE DUTY.
METAL EDGE MOLDINGS AND TRIM: ROLL-FORMED SHEET METAL.

INSTALLATION
 A. INSTALLATION: [ASTM C 636] [UBC STANDARD 25-2].

 IEELD OUALITY CONTROL
 A. TESTING: BY [OWNER] [CONTRACTOR]-ENGAGED AGENCY TO TEST ACOUSTICAL PANEL CEILING HANGER FASTENERS.

END OF SECTION 095113.

FINISHES (CONTINUED)

SECTION 096516 - RESILIENT SHEET FLOORING

N 096516 - RESILIENT SHEET FLOORING
PRODUCTS
A. FLOORING SYSTEM: FLOORSCORE COMPLIANCE.

INVIL SHEET FLOORING:
BACKING: NONE, UNBACKED [NONFOAMED PLASTIC] [FOAMED PLASTIC].
2. SEAMLESS-INSTALLATION METHOD: HEAT WELDED.

C. RUBBER SHEET FLOORING:
1. BACKING: NONE, UNBACKED.
2. SEAMLESS-INSTALLATION METHOD: HEAT WELDED.

D. INSTALLATION MATERIALS:
E. TROWELABLE LEVELING AND PATCHING COMPOUNDS: LATEX-MODIFIED, PORTLAND CEMENT BASED OR BLENDED HYDRAULIC-CEMENT-BASED FORMULATION PROVIDED OR APPROVED BY RESILIENT SHEET FLOORING MANUFACTURER FOR APPLICATIONS INDICATED. MANUEACTURER FOR APPLICATIONS INDICATED

ADHESIVES: WATER-RESISTANT TYPE RECOMMENDED BY ELOORING AND ADHESIVE MANUFACTURERS TO SUIT RESILIENT SHEET FLOORING AND SUBSTRATE CONDITIONS INDICATED.

VINYL SHEET ADHESIVES SHALL HAVE A VOC CONTENT OF 50 G/L

RUBBER SHEET ADHESIVES SHALL HAVE A VOC CONTENT OF 60 G/L

INTEGRAL-FLASH-COVE-BASE ACCESSORIES: COVE STRIP: 1 INCH (25 MM) RADIUS PROVIDED OR APPROVED BY RESILIENT SHEET FLOORING MANUFACTURER

RESULENT SHEET FLOORING MANUFACTURER.
CAP STRIP. [SQUARE METAL, VINYL, OR RUBBER CAP] [TAPERED VINYL CAP] «INSERT REQUIREMENTS» PROVIDED OR APPROVED BY RESULENT SHEET FLOORING MANUFACTURER. FLOOR POLISH: PROVIDED PROTECTIVE, LIQUID FLOOR-POLISH PRODUCTS RECOMMENDED BY RESILIENT SHEET FLOORING MANUFACTUREP.

MANUFACTURER

SECTION 097200 - WALL COVERINGS

1.1 SUMMARY
A. WINYL AND WOVEN GLASS-FIBER WALL COVERING.

MATERIALS
A. ADHESIVE: MILDEW-RESISTANT, NONSTAINING, STRIPPABLE ADHESIVE, FOR USE WITH SPECIFIC WALL COVERING AND SUBSTRATE APPLICATION, AS RECOMMENDED IN WRITING BY WALL-COVERING MANUFACTURER, AND WITH A VOC CONTENT OF 50 GL, OR LESS WHENEN CALCULATED ACCORDING TO O CFR 59, SUBPART D (EPA METHOD 24).

INSTALLATION

INSTALL STRIPS IN SAME ORDER AS CUT FROM ROLL END OF SECTION 097200

SECTION 099123 - INTERIOR PAINTING

SURFACE PREPARATION AND THE APPLICATION OF PAINT SYSTEMS ON INTERIOR SUBSTRATES.

SUBMITTALES
A. SAMPLES FOR VERIFICATION:
1. FOR EACH NON-STANDARD LATEX TOPCOAT COLOR AND GLOSS INDICATED.
FOR EACH TYPE OF NON-STANDARD PAINT SYSTEM AND IN EACH COLOR AND GLOSS OF TOPCOAT INDICATED.

CUALITY ASSURANCE

A. QUALITY STANDARDS: "MPI APPROVED PRODUCTS LIST" AND "MPI ARCHITECTURAL PAINTING SPECIFICATION MANUAL."

B. MOCKUPS FOR EACH COLOR AND FINISH.

B. MOCKUPS FOR EACH COLOR AND FINISH.
GENERAL
A. VOC CONTENT: PRODUCTS SHALL COMPLY WITH VOC LIMITS OF
A. AUTHORITIES HAVING JURISDICTION [AND, FOR INTERIOR PAINTS AND
COATINGS APPLIED AT PROJECT SITE. THE FOLLOWING VOC LIMITS,
EXCLUSIVE OF COLORANTS ADDED TO A TINT BASE, WHEN CALCULATED
ACCORDING TO 40 CFR 59, SUBPART D (EPA METHOD 24)].
1. FLAT PAINTS AND COATINGS: 50 G/L.
2. NONFLAT PAINTS AND COATINGS: 51 G/L.
3. DRY-FOG COATINGS: 400 G/L.
4. PRIMERS, SEALERS, AND UNDERCOATERS: 200 G/L.
5. ANTICORROSIVE AND ANTIRORY PAINTS APPLIED TO FERROUS
METALS: 250 G/L.

ANTICORROSIVE AND ANTIRUST PAINTS APPLIED TO FERI METALS: 250 G/L. ZINC-RICH INDUSTRIAL MAINTENANCE PRIMERS: 340 G/L. PRETREATMENT WASH PRIMERS: 420 G/L.

FLOOR COATINGS: 100 G/L

SHELLACS, CLEAR: 730 G/L SHELLACS, PIGMENTED: 550 G/L

INTERIOR PAINTING SCHEDULE

STEEL SUBSTRATES:

INSTITUTIONAL LOW-ODOR/VOC LATEX SYSTEM: UTIONAL LOW-ODOR/VOC LATEX SYSTEM:
PRIME COAT: PRIMER, RUST-INHIBITIVE, WATER BASED.
TOPCOAT: INSTITUTIONAL LOW-ODOR/VOC INTERIOR
LATEX (GLOSS LEVEL AS INDICATED IN PAINT SCHEDULE).

GALVANIZED-METAL SUBSTRATES:

1. INSTITUTIONAL LOW-ODDR/VOC LATEX SYSTEM:

a. PRIME COAT: PRIMER, GALVANIZED, WATER BASED.

b. TOPCOAT: LATEX, INTERIOR, INSTITUTIONAL LOW
ODDR/VOC, (GLOSS LEVEL AS INDICATED IN PAINT
SCHEDULE).

ODDRIVOC. (GLOSS LEVEL AS INDICATED IN PAINT SCHEDULE).

WOOD SUBSTRATES:

1. INSTITUTIONAL LOW-ODDRIVOC LATEX SYSTEM:
a. PRIME COAT: INTERIOR LATEX PRIMERISEALER.
b. TOPCOAT: INSTITUTIONAL LOW-ODDRIVOC INTERIOR LATEX (GLOSS LEVEL AS INDICATED IN PAINT SCHEDULE).

GYPSUM BOARD SUBSTRATES:
1. INSTITUTIONAL LOW-ODDRIVOC LATEX SYSTEM:
a. PRIME COAT: INTERIOR LATEX PRIMERISEALER.
b. TOPCOAT: INSTITUTIONAL LOW-ODDRIVOC INTERIOR LATEX (GLOSS LEVEL AS INDICATED IN PAINT SCHEDULE).

HIGH-IMPACT GYPSUM BOARD SUBSTRATES:
1. HIGH-PERFORMANCE ARCHITECTURAL LATEX SYSTEM:
a. PRIME COAT: INTERIOR LATEX PRIMERISEALER.
b. TOPCOAT: INSTITUTIONAL LOW-ODDRIVOC INTERIOR LATEX (GLOSS LEVEL AS INDICATED IN PAINT SCHEDULE).

PLASTER SUBSTRATES:

PLASTER SUBSTRATES:

1. INSTITUTIONAL LOW-ODOR/VOC LATEX SYSTEM:

1. INSTITUTIONAL LOW-ODOR/VOC LATEX SYSTEM:

1. INSTITUTIONAL LOW-ODOR/VOC LATEX PRIMERSEALER.

2. TOPCOAT: INSTITUTIONAL LOW-ODOR/VOC INTERIOR

LATEX (GLOSS LEVEL AS INDICATED IN PAINT SCHEDULE).

PRIME COAT: INTERIOR LATEX PRIMER/SEALER TOPCOAT: INSTITUTIONAL LOW-ODOR/VOC INTERIOR LATEX (GLOSS LEVEL AS INDICATED IN PAINT SCHEDULE).

END OF SECTION 099123

FINISHES (CONTINUED)

SECTION 09930 - WOOD STAINS AND TRANSPARENT FINISHES

1.1 SUMMARY
A SURFACE PREPARATION AND APPLICATION OF WOOD FINISHES ON [EXTERIOR] [AND] [INTERIOR] SUBSTRATES.

1.2 SUBMITTALS
A SAMPLES FOR VERIFICATION: FOR EACH TYPE OF FINISH SYSTEM AND IN EACH COLOR AND GLOSS OF FINISH INDICATED.

1.3 QUALITY ASSURANCE
A. QUALITY STANDARDS: "MPI APPROVED PRODUCTS LIST" AND "MPI ARCHITECTURAL PAINTING SPECIFICATION MANUAL"

GENERA

CHEMICAL COMPONENTS OF FIELD-APPLIED INTERIOR PAINTS AND COATINGS:

IICAL COMPONENTS OF FIELD-APPLIED INTERIOR PAINTS AND COATINGS VOC LIMITS:

a. CLEAR WOOD FINISHES, VARNISHES: VOC NOT MORE THAN 350 G/L.

b. SHELLACS, CLEAR: VOC NOT MORE THAN 730 G/L.

c. STAINS: VOC NOT MORE THAN 250 G/L.

d. PRIMERS, SEALERS, AND UNDERCOATERS: 200 G/L.

e. FIRE RETARDANT COATINGS, CLEAR: 650 G/L.

f. FIRE RETARDANT COATINGS, PIGMENTED: 350 G/L.

f. FIRE RETARDANT COATINGS, PIGMENTED: 350 G/L

1.5 EXTERIOR WOOD-FINISH-SYSTEM SCHEDULE
A. SOLID-COLOR LATEX STAIN SYSTEM: MPI EXT 6.3K.

1. PRIME COAT: PRIMER, LATEX FOR EXTERIOR WOOD.
2. INTERNIEDIATE COAT: STAIN, EXTERIOR, WATER BASED, SOLID HIDE, MATCHING TOPCOAT.
3. TOPCOAT: STAIN, EXTERIOR, WATER BASED, SOLID HIDE.
B. SEMITRANSPARENT STAIN SYSTEM: MPI EXT 6.3D.
1. TWO STAIN COATS: EXTERIOR SEMITRANSPARENT LATEX STAIN.

1.6 INTERIOR WOOD-FINISH-SYSTEM SCHEDULE
A SEMITRANSPARENT STAIN SYSTEM:

I/OR WOOD-FINISH-SYSTEM SCHEDULE
SEMITRANSPARENT STAIN SYSTEM.

1. PRIME COAT: STAIN, SEMI-TRANSPARENT, MATCHING TOPCOAT.
2. TOPCOAT: STAIN, SEMI-TRANSPARENT, FOR INTERIOR WOOD.
WATER-BASED VARNISH SYSTEM:
a. PRIME COAT: WATER-BASED VARNISH MATCHING TOPCOAT.
b. INTERMEDIATE COAT: WATER-BASED VARNISH MATCHING TOPCOAT.
c. TOPCOAT: VARNISH, WATER BASED, CLEAR.
WATER-BASED FIRE RETARDANT SYSTEM:
a. TOPCOAT: FIRE RETARDANT COATING, CLEAR.
1. CLASS A ELAME SPREAD AND SMOKE-DEVELOPED INDEX PER
ASTM E 84.

ON 09930

END OF SECTION 09930



STARBUCKS COFFEE COMPANY

2401 UTAH AVENUE SOUTH SEATTLE, WASHINGTON 98134 (206) 318-1575

THESE DRAWINGS AND SPECIFICATIONS ARE CONFIDENTIAL AND SHAL REMAN THE SOLE PROPERTY OF STABBLICKS CORPORATION, WHICH THE OWNERS OF THE CONFIGURATION SHALL THE OWNER OF THE CONFIDENCE THE WORK THE SHALL NOT EST USED IN ARY MANNER ON OTHER PROJECTS OR EXTENSIONS TO THIS USED IN ARY MANNER ON OTHER PROJECTS OR EXTENSIONS TO THIS PROJECT WITHOUT THE PRIOR WHITE CONSENT OF STABBLICKS CORPORATION. THESE DRAWINGS AND SPECIFICATIONS ARE INTENDED.

ARCHITECT OF RECORD

ENGINEER OF RECORD

Phone (314) 772-1782 Fax (314) 772-0108 Engineering Consultant

Rev Date By Descript

PROJECT ADDRESS: 920 WATER STREET MILWAUKEE, WI 53202 ROW AR Ω Ш \simeq

STORE #: PROJECT #: 14516-022 CONCEPT NCS PAI ETTE: HERITAGE ISSUE DATE: 10.17.13 DESIGN MANAGER: S. RYCHLIK LEED® AP-

PRODUCTION DESIGNER: C. ALINOVICH, NORR

CHECKED BY SHEET TITLE

DESIGN SPECIFICATIONS

K GORIN NORR

SCALE:







STARBUCKS COFFEE COMPANY 2401 UTAH AVENUE SOUTH SEATTLE, WASHINGTON 98134 (206) 318-1575

ARCHITECT OF RECORD

ENGINEER OF RECORD

WA

Engineering Consultant

PROJECT NAME:
RED ARROW
PROJECT ADDRESS:
920 WATER STREET
MILWAUKEE, WI 53202


STORE #: PROJECT #: 14516-022 CONCEPT: NCS PALETTE: HERITAGE ISSUE DATE:

DESIGN MANAGER: S. RYCHLIK LEED® AP:

PRODUCTION DESIGNER: C. ALINOVICH, NORR CHECKED BY: K. GORIN, NORR

SHEET TITLE:
ARCHITECTURAL SITE
PLAN SCALE: 1" = 20'-0"

A-1001

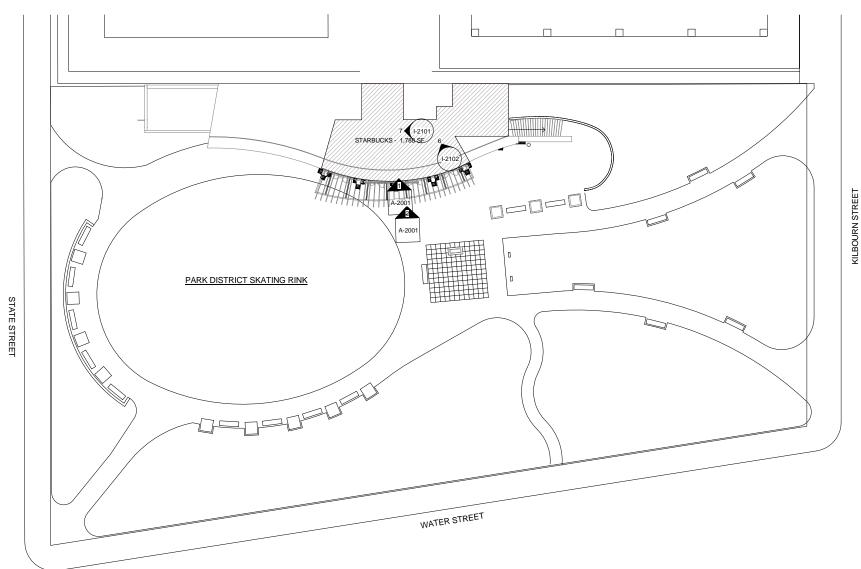

	SIGNAGE SCHEDULE - "S"							
DESIGN ID	COUNT	DESCRIPTION	RESP.	BULB	COMMENTS			
SIGNAGE - I	IGNAGE - DISK							
13163		SIGN - DISK SF ILLUMINATED FLUSH MOUNTED EVOLVED - 48IN 1220MM	SB		BY HILTON DISPLAYS. TRACIE GESEL. 864.233.0401. TRACIEGESEL@HILTONDISPLAYS.COM			

AI.	LOWED SIGNAGE RQMTS:
	LOTTED GIGHT TOE ITQUITO.

South Elevation Allowed Signage: 32 SF Proposed Signage: 32 SF

PROPOSED SIGNAGE:

Logo Disk - ID: 13163 (Qty: 2) Area: 16 SF (Internally Illuminated Inline) Height: 48in

Proposed Signage Total Area: 32F

SHEET NOTES

- 1. INSTALL NEW FLUSH MOUNTED, 48IN LOGO DISK.
- 2. EXISTING GREEN CHANNEL LETTERS TO REMAIN.

EXTERIOR ELEVATION NOTES

A. GENERAL CONTRACTOR TO COORDINATE AND SCHEDULE SIGNAGE INSTALLATION WITH THE SIGNAGE CONTRACTOR PROVIDING A MINIMUM SCHEDULING NOTICE OF 4 WEEKS AND 1 WEEK PRIOR TO SCHEDULED DATE OF INSTALLATION. STARBUCKS CONSTRUCTION MANAGER TO PROVIDE GENERAL CONTRACTOR WITH SIGNAGE CONTRACTOR CONTRACT INFORMATION.

B. GENERAL CONTRACTOR SHALL COORDINATE WITH ELECTRICAL CONTRACTOR TO FURNISH AND INSTALL ELECTRICAL CIRCUITS INCLUDING ALL CONDUIT, WIRE, CONNECTIONS, AND BREAKER AT PANEL BOARD NECESSARY TO SERVE SIGNAGE.

C. GENERAL CONTRACTOR TO PROVIDE FIRE TREATED WOOD STUD BLOCKING, OR EQUIVALENT TO SUPPORT SIGNAGE.

D. SIGNAGE CONTRACTOR SHALL VERIFY SIZE AND LOCATION OF ANY AND ALL ALLOWABLE MONUMENT OR POLE SIGNAGE WITH LANDLORD AND PROVIDE SHOP DRAWING(S) PRIOR TO FABRICATION TO STARBUCKS DESIGNER FOR APPROVAL.

E. SIGNAGE CONTRACTOR TO INSTALL SIGNAGE IN COMPLIANCE WITH LOCAL CODES AND OBTAIN PERMIT AND LANDLORD APPROVAL.

F. SIGNAGE CONTRACTOR TO SUPPLY SHOP DRAWINGS TO STARBUCKS CONSTRUCTION MANAGER AND TO THE GENERAL CONTRACTOR AS NEEDED. GENERAL CONTRACTOR TO NOTIFY STARBUCKS CONSTRUCTION MANAGER IMMEDIATELY IF SHOP DRAWINGS OR INSTALLATION IS IN DISCREPANCY WITH STARBUCKS ARCHITECTURAL DRAWINGS.

 ${\bf G}.$ GENERAL CONTRACTOR TO CLEAN, PATCH AND REPAIR EXISTING EXTERIOR AS REQUIRED.

H. SEE SCHEDULE SHEETS FOR SIGNAGE SCHEDULE.

STARBUCKS COFFEE

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ARCHITECT OF RECORD

ENGINEER OF RECORD Phone (314) 772-1782 Fax (314) 772-0108

Engineering Consultant

	Revision Schedule					
Rev	Date	Ву	Description			
1	10.17.13		Revision 1			

PROJECT NAME:
RED ARROW
PROJECT ADDRESS:
920 WATER STREET
MILWAUKEE, WI 53202

STORE #: PROJECT #: 14516-022 CONCEPT: NCS PALETTE: HERITAGE

ISSUE DATE: 10.17.13 DESIGN MANAGER: S. RYCHLIK LEED®AP:

PRODUCTION DESIGNER: C. ALINOVICH, NORR CHECKED BY: K GORIN NORR

SHEET TITLE

EXTERIOR ELEVATIONS

SCALE:



EXISTING EXTERIOR ELEVATION -FOR REFERENCE

Scale: 1/8" = 1'-0"



2 ELEVATION AT ENTRY
Scale: 1/R* = 1'.^*

As indicated

A-2001

ITEM TO PRESERVE: ESPRESSO MACHIENS (2) DOUBLE BREWER WARMING SHUTTLES (2) POS EQUIPMENT BLENDERS (2) ICE MACHINE GG MOP SINK HH. WATER FILTRATION SYSTEM II. METRO STORAGE (7) JJ. 1-DR FREEZER (1) KK. 2-DR FRIDGE (1) LL. LOCKERS MM. COAT HOOK MM. COAT HOOK NN. FIRE EXTINGUISHER OO. THERMOSTAT/SECURITY PP. ELECTRIC PARILS OQ. FIREPLACE RR. ATM MACHINES SL LOCKERS TT. SKATE RENTAL COUNTER UU. TRASH CANS VV. WATER FOUNTAIN WW. MERCH BASKETS/CUBES XX. NEWSPAPER STAND YY. GRINDER ZU. UNDERCOUNTER REFRIGERATORS AAA. SANITIZER

ITEMS TO DEMOLISH: SHEET NOTES

PASTRY CASE

6. CAFE CHAIRS 7. CAFE TABLES

- . BREW STATION/CASEWORK 2. CBS STATION/CASEWORK 3. ESPRESSO STATION/CASEWORK 4. POS STATION/CASEWORK 23. GC TO VERIFY IN FIELD PRIOR TO DEMOLITION IF CHASE CAN BE DEMOLISHED.
 - 24. GC TO VERIFY IF WALL IS LOAD-BEARING AT PRE-BID. CONTACT ARCHITECT IMMEDIATELY IF REINFORCEMENT SHORING IS REQUIRED.
- 7. CAFE TABLES

 8. COLUMN COUNTERS

 9. SOFT SEATING

 10. OUTDOOR CHAIRS

 11. OUTDOOR TABLES

 12. OUTDOOR BENCHES

 13. LOGO DISK

 14. ADA TABLE

 15. 1-COMP SINK

 16. MANAGER'S DESK, SHELVING, RACK

 17. CONDIMENT CART

 18. SIDE TABLE

 19. COFFEE STAND

 20. PROMOTIONAL RACK

 21. BANNER STAND

 22. BAR HEIGHT CHAIR 25. GC TO DEMO DOOR AND FRAME. PREP OPENING FOR INFILE 26. GC TO DEMO SWING DOOR AND FRAME. PREP OPENING FOR BYPASS DOORS.

DEMOLITION PLAN NOTES

- A. IF DURING DEMOLITION CONDITIONS ARE REVEALED THAT MAY JEOPARDIZE INTEGRITY OF STRUCTURE OR PRECLUDE FOLLOWING DESIGN INTERN. GENERAL CONTRACTOR TO NOTIFY STARBUCKS CONSTRUCTION MANAGER IMMEDIATELY.
- B. GENERAL CONTRACTOR RESPONSIBLE FOR SITE INVESTIGATION PRIOR TO DEMOLITION TO REVEAL FULL SCOPE OF WORK.
- C. EXISTING WALLS TO REMAIN. PATCH AND REPAIR AS REQUIRED TO PROVIDE A SMOOTH, PAINT READY FINISH.
- D. DEMOLISH EXISTING WALLS AND DOORS AS NECESSARY.
- E. DEMOLISH EXISTING FLOOR FINISHES AS NECESSARY. REPAIR OR REPLACE SUB-FLOOR AS REQUIRED TO PROVIDE AN EVEN WALKING SURFACE/FINISH FLOOR CONDITION.
- F. DEMOLISH EXISTING GYPSUM WALL BOARD, CEILING TILE, GRID AND/OR OTHER CEILING FINISH AS NECESSARY TO PROVIDE FOR NEW CEILING READY CONDITION.
- G. DEMOLISH EXISTING WALL FINISHES AS NECESSARY.
- H. REMOVE EXISTING LIGHT FIXTURES. AUXILIARY EQUIPMENT/FIXTURES AND POWER LINES AS NECESSARY.
- J. REMOVE EXISTING PLUMBING FIXTURES AS NECESSARY. CAP LINES AS NECESSARY FOR THOSE NOT BEING REUSED.
- K. REMOVE EXTRANEOUS EQUIPMENT AS NECESSARY
- L. GENERAL CONTRACTOR TO NOTIFY ARCHITECT OF SIZE OF EXISTING RESTROOM AND LOCATION AND CONDITION OF FIXTURES PRIOR TO DEMOLITION OR CONSTRUCTION.
 PLUMBING FIXTURES TO BE RE-USED ARE TO BE REMOVED AND PROPERLY STORED FOR RE-INSTALLATION.



STARBUCKS COFFEE **COMPANY**

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ARCHITECT OF RECORD

ENGINEER OF RECORD

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Engineering Consultant

Rev Date By Description

PROJECT ADDRESS: 920 WATER STREET MILWAUKEE, WI 53202 ARROW PROJECT RED

STORE #: PROJECT #: 14516-022 CONCEPT: NCS PAI ETTE: HERITAGE ISSUE DATE:

LEED® AP: PRODUCTION DESIGNER: C.ALINOVICH, NORR CHECKED BY K GORIN NORR

SHEET TITLE

DESIGN MANAGER:

DEMOLITION FLOOR PLAN


S. RYCHLIK

As indicated

SHEET NUMBER:

I-1101

SCALE

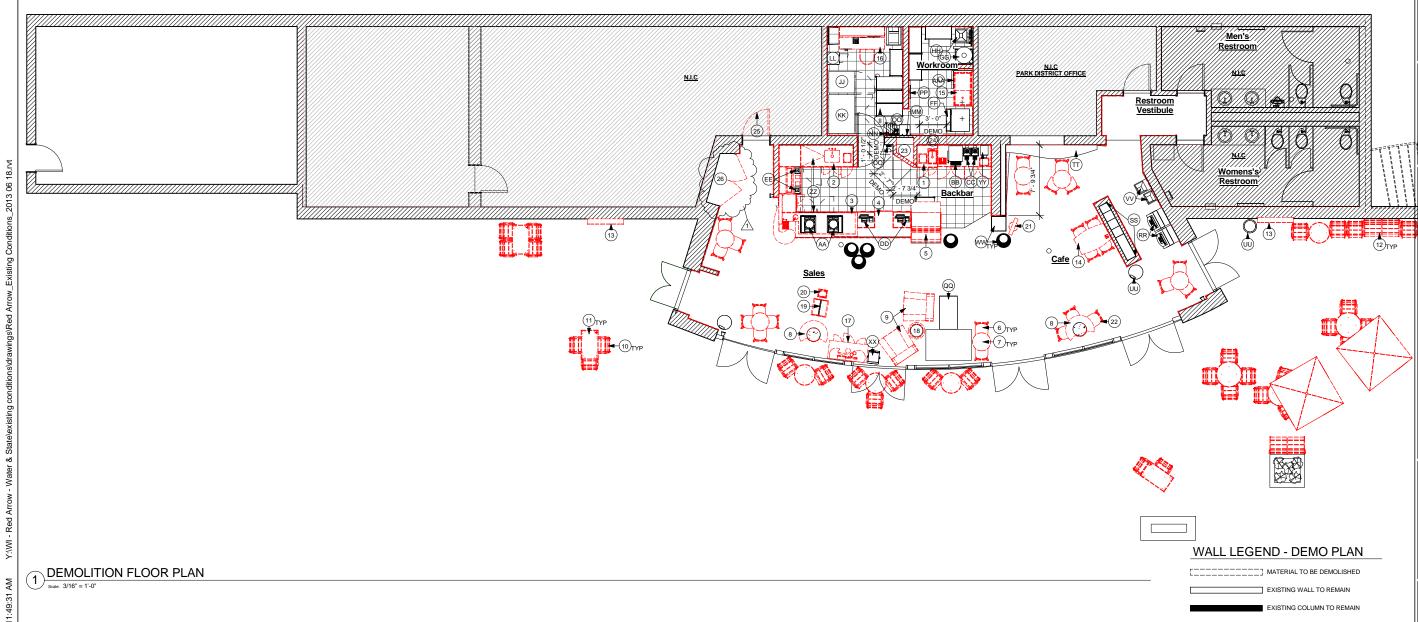

ITEM TO PRESERVE:

- AA. BACKBAR GYP BOARD SOFFIT BB. RECESSED CAN LIGHTING CC. TRACK LIGHT HEADS & TRACK DD. 224 TROFFER LIGHTS EE. HVAC DUCTS & VENTS FF. SPEAKERS GG. 292 WORKROOM ACT CEILING HH. SECURITY CAMERA

ITEMS TO DEMOLISH:

- GYP BOARD SOFFIT
 SUSPENDED 2x2 ACT PANELS
 DECORATIVE HANDOFF PLANE PENDANT
 MENU BOARDS
 LOGO DISK

DEMOLITION RCP NOTES

A. IF DURING DEMOLITION CONDITIONS ARE REVEALED THAT MAY JEOPARDIZE INTEGRITY OF STRUCTURE OR PRECLUDE FOLLOWING DESIGN INTENT, GENERAL CONTRACTOR TO NOTIFY STARBUCKS CONSTRUCTION MANAGER IMMEDIATELY.

B. GENERAL CONTRACTOR RESPONSIBLE FOR SITE INVESTIGATION PRIOR TO DEMOLITION TO REVEAL FULL SCOPE OF WORK.

C. EXISTING WALLS TO REMAIN. PATCH AND REPAIR AS REQUIRED TO PROVIDE A SMOOTH, PAINT READY FINISH.

D. DEMOLISH EXISTING GYPSUM WALL BOARD, CEILING TILE, GRID AND/OR OTHER CEILING FINISH AS NECESSARY TO PROVIDE FOR NEW CEILING READY CONDITION.

E. DEMOLISH EXISTING WALL FINISHES AS NECESSARY.

G. REMOVE EXTRANEOUS EQUIPMENT AS NECESSARY.



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COMPANY 2401 UTAH AVENUE SOUTH SEATTLE, WASHINGTON 98134 (206) 318-1575

ARCHITECT OF RECORD

ENGINEER OF RECORD

Engineering Consultant

PROJECT NAME:
RED ARROW
PROJECT ADDRESS:
920 WATER STREET
MILWAUKEE, WI 53202

STORE #: PROJECT #: 14516-022 CONCEPT: NCS PALETTE: HERITAGE ISSUE DATE: DESIGN MANAGER: S. RYCHLIK


PRODUCTION DESIGNER: C.ALINOVICH, NORR CHECKED BY: K. GORIN, NORR

SHEET TITLE:

LEED® AP:

DEMOLITION CEILING **PLAN**

SCALE:

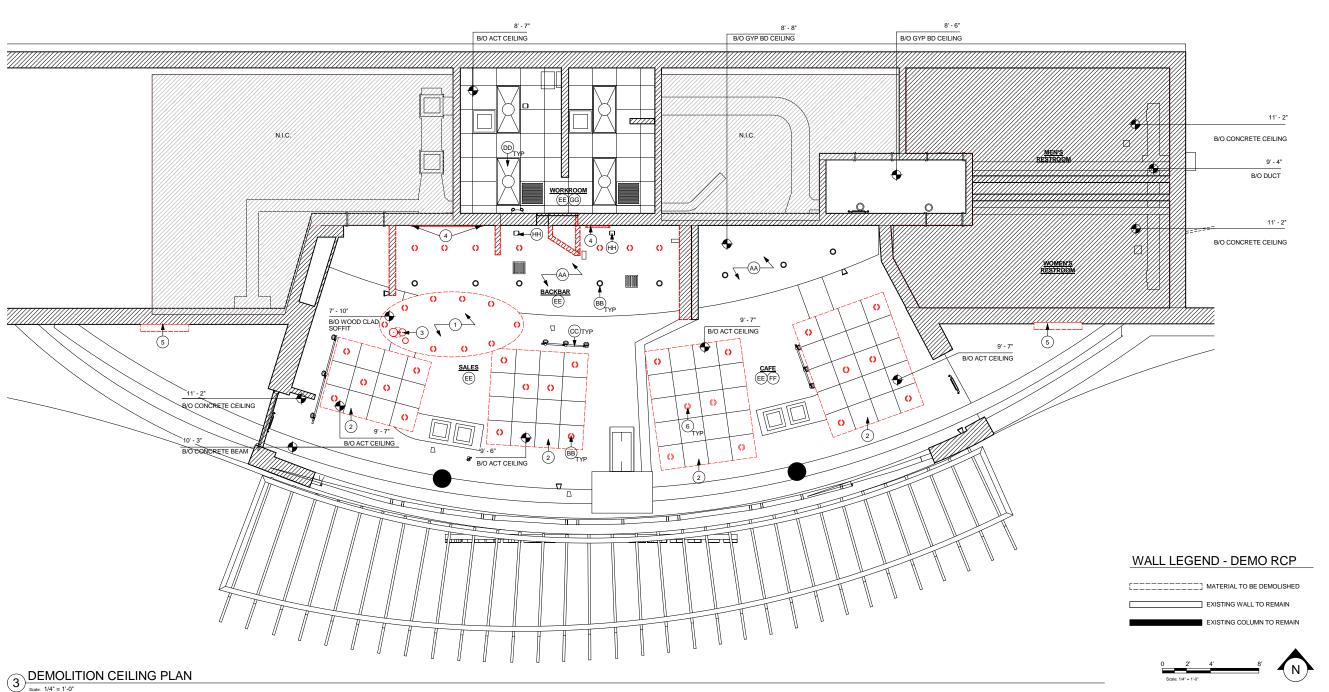

WALL BLOCKING KEY Symbol Item Height Approximate Width A Shelves Above 3-Comp Sink 200LBS 5'-8" to 6'-0" 6'-0" Centered Above 3-Comp Sink B Shelves and Data Rack at Manager's Desk 300LBS 1/2" ACX Plywood 7'-0" Centered Above

300LBS

Provide fire treated 2x6 or 2x8 wood stud blocking as required to support any wall attachments

DOOR TYPE & HARDWARE LEGEND



SET #11
(1) ELIASON DOOR PACKAGED WITH HARDWARE. (VD)

Upper Storage (Cubby)

FLOOR PLAN NOTES

DOOR SCHEDULE - "D"

COMMERCIAL GRADE SLIDING COMMERCIAL GRADE SLIDING
BYPASS DOOR WITH ALUMINIUM
TRACK AND FASCIA, 2-DR
CONFIGURATION, MODEL 138F.
DOOR THICKNESS: 1-3/8". BRONZE
ANODIZED TRACK AND HARDWARE.
STAIN TO MATCH WD0001. JOHNSON

HARDWARE. WWW.JOHNSONHARDWARE.COM. T:

800.837.5664. INFO@JOHNSONHARDWARE.COM

LOCKNET, ELIASON DOOR WITH

HARDWARE. FINISH WILSONART PL0014 - MONTANA WALNUT.

CAFE

DESCRIPTION

COMMERCIAL GRADE BYPASS DOOR

DOOR - SINGLE IMPACT DOUBLE ACTING -

DESIGN ID COUNT

A. GENERAL CONTRACTOR TO VERIFY ALL DIMENSIONS AND A. GENERAL CONTRACTOR TO VERIFY ALL DIMENSIONS AND NOTIFY STARBUCKS CONSTRUCTION MANAGER OF ANY DISCREPANCIES PRIOR TO CONSTRUCTION. ALL DIMENSIONS TO BE TAKEN FROM DESIGNATED DATUM POINT.

B. IF EXISTING EXTERIOR ENTRANCE THRESHOLD EXCEEDS B. IF EARS INIO EXTERIOR EN IRANCE INKESHOLD EXCELEDS REQUIRED AMERICAN'S WITH DISABILITY ACT (ADA) MAXIMUM HEIGHT OF 1/2' (10MM), REMOVE AND REPLACE WITH ACCESSIBLE THRESHOLD. RAISED THRESHOLDS AND FLOOR LEVEL CHANGES AT ACCESSIBLE DOORWAYS TO BE BEVELED WITH A SLOPE NO GREATER THAN 1:12.

C. GENERAL CONTRACTOR TO PROVIDE FIRE TREATED WOOD STUD BLOCKING, OR EQUIVALENT TO SUPPORT ANY WALL ATTACHMENT AND/OR SIGNAGE.

D. ALL DOORS TO PROVIDE 3'-6" (900MM) MINIMUM CLEAR OPENING WHEN OPENED TO 90 DEGREE POSITION UNLESS OTHERWISE NOTED.

F. INSTALL 1/4" (6MM) GREEN BOARD ON BACKBAR WALL PER SPECIFICATION.

SHEET NOTES

1. INSTALL 5/8" TILE BACKER BOARD ON BACKBAR

2. CONSTRUCT NEW FULL-HEIGHT WALL WHERE INDICATED.

3. NEW ELIASON DOOR

4. NEW BYPASS DOOR AT STORAGE.

RESTROOM VESTIBUL

5. PATCH, REPAIR, AND PAINT WALL AS REQUIRED. 6. REVERSE DOOR SWING WHERE INDICATED.

RESTROOM

WOMEN'S RESTROOM

ENGINEER OF RECORD Phone (314) 772-1782 Fax (314) 772-0108

STARBUCKS COFFEE

COMPANY
2401 UTAH AVENUE SOUTH

SEATTLE, WASHINGTON 98134 (206) 318-1575

ARCHITECT OF RECORD

Engineering Consultant

Description

ARROW RED PROJECT

STORE #: PROJECT #: 14516-022 CONCEPT: NCS PAI ETTE: HERITAGE

ISSUE DATE: 10.17.13 DESIGN MANAGER: S. RYCHLIK LEED® AP:

PRODUCTION DESIGNER: C. ALINOVICH, NORR CHECKED BY K GORIN NORR

SHEET TITLE:

FLOOR PLAN

As indicated

SCALE:

I-1103

DOOR HARDWARE

8' - 5" B PAR K DISTRICT UTILITY ROOM N.I.C. PARK DISTRICT OFFICE /N.I.C. WORKROOM

Manager's Desk and Data Rack

Extent of Backbar Upper

FLOOR PLAN

6

WALL LEGEND - FLOOR PLAN

EXISTING WALL

EXISTING COLUMN

NEW FULL HEIGHT WALL

NEW PARTIAL HEIGHT WALL

STUB UPS - DOUBLE POS/SAFE

- ALL CONDUIT STUB UPS TO BE WITHIN THIS BOUNDARY CWF STUB UF

3 STUB UPS - ESPRESSO Scale: 1 1/2" = 1'-0"

ALL CONDUIT STUB UPS TO BE WITHIN THIS BOUNDARY DIMENSION DATUM POINT 3/4" LAN CONDUIT TO POS / SAFE

3/4" ISOLATED GROUND POWER CONDUIT STUB UPS - FRONTBAR

3/4" LAN CONDUIT

Caulk joint No-hub connection

Floor Drain Section

MÉN'S PAR K DISTRICT UTILITY ROOM RESTROOM NIC N.I.C./ WOMEN'S 5 I-1104 RESTROOM N.I.C. BACKBAR CAFE

PENETRATION PLAN NOTES

A. ALL STUB-UP DIMENSIONS ARE RELATIVE TO FINISHED WALL LOCATIONS (SHOWN AS OUTLINES ON THIS PLAN). REFER TO FLOOR PLAN FOR WALL PLACEMENT.

B. FLOOR SINK: REFER TO CUT SHEETS FOR COMPONENT SPECIFICATIONS AND CUTOUT REQUIREMENTS.

C. WASTE LINE PENETRATIONS: REFER TO PLUMBING PLANS FOR INDIVIDUAL LINE SPECIFICATIONS.

D. STUB-UP PENETRATIONS: REFER TO PLUMBING PLANS FOR INDIVIDUAL STUB-UP SPECIFICATIONS.

E. TOILET FLOOR PENETRATION: REFER TO CUT SHEETS FOR STUB-UP LOCATION RELATIVE TO FINISHED WALL.

F. PENETRATION TO BE LOCATED ON CENTERLINE OF WALL OR AS REQUIRED PER CONDITIONS.

G. TRENCHING OUTLINE FOR GUIDELINE USE ONLY. GENERAL CONTRACTOR TO COORDINATE WITH SPECIFIC TRADES AND SITE CONDITIONS TO DETERMINE ACTUAL LAYOUT.

SHEET NOTES

1. FLOOR SINK. SEE CUTSHEETS FOR COMPONENT

2. STUB-UP PENETRATIONS. SEE PLUMBING AND ELECTRICAL SHEETS FOR INDIVIDUAL STUB-UP SPECIFICATIONS.

3. ALL STUB-UP DIMENSIONS ARE RELATIVE TO FNIISHED WALL LOCATIONS. REFER TO FLOOR PLAN FOR REPLACEMENT.

4. UTILIZE EXISTING FLOOR SINKS AND STUB-UPS WHERE POSSIBLE. GC TO VERIFY DURING PRE-CONSTRUCTION MEETING WITH STARBUCKS PM.



STARBUCKS COFFEE COMPANY 2401 UTAH AVENUE SOUTH

SEATTLE, WASHINGTON 98134 (206) 318-1575

ARCHITECT OF RECORD

ENGINEER OF RECORD

Engineering Consultant

PROJECT NAME:
RED ARROW
PROJECT ADDRESS:
920 WATER STREET
MILWAUKEE, WI 53202

STORE #: PROJECT #: 14516-022 CONCEPT: NCS PALETTE: HERITAGE

ISSUE DATE: DESIGN MANAGER: S. RYCHLIK LEED® AP:

PRODUCTION DESIGNER: C. ALINOVICH, NORR CHECKED BY K. GORIN. NORR

SHEET TITLE

PENETRATION PLAN

As indicated

I-1104

SCALE:

1) PENETRATION PLAN

PENETRATION PLAN LEGEND

FLOOR PENETRATION

PLUMBING PENETRATION AREA

ELECTRICAL PENETRATION AREA

2. EXISTING LOCKERS TO BE RELOCATED. SECURE LOCKERS TO WALL.

3. PLACE FIRE EXTINGUISHER IN WORKROOM PER FIRE INSPECTOR.

4. NEW LOCATION OF ALL SWITCHING.

 ${\tt 5.}$ SPEAKERS TO BE MOUNTED AT MAXIMUM HEIGHT PER CUTSHEET.

6. SEE ELEVATIONS FOR DISTRIBUTION OF CUP DISPENSERS.

7. NEW DOOR HARDWARE

8. EXISTING PARK DISTRICT LOCKERS TO REMAIN.

9. EXISTING FIREPLACE TO REMAIN. 10. NEW BYPASS DOOR AT STORAGE.

E DENOTES EXISTING ITEM TO BE RELOCATED.

FF AND E PLAN NOTES

A. GENERAL CONTRACTOR TO SCHEDULE WITH LOCAL REFRIGERATION CONTRACTOR TO CONDUCT INITIAL FOOD CASE START-UP AND TESTING. FOR APPROVED CONTRACTOR, CONTACT VENDOR.

B. THE SPACE IS SERVED BY THE MUNICIPAL WATER AND SEWER SYSTEM UNLESS OTHERWISE NOTED.

C. ALL EQUIPMENT AND INSTALLATION WILL MEET NATIONAL SANITATION FOUNDATION STANDARDS OR EQUIVALENT.

D. EQUIPMENT UNITS SHALL CONTAIN NO EXPOSED THREADS, EMBELLISHMENTS OR OVERHANGING EDGES THAT SERVE AS PLACES FOR ACCUMULATION OF DUST, DIRT AND DEBRIS.

E. EACH HAND WASHING SINK WILL HAVE A SINGLE SERVICE TOWEL AND SOAP DISPENSER, AND ALL HAND SINKS TO HAVE A COMBINATION FAUCET OR PREMIXING FAUCET.

F. FOR PLUMBING FIXTURES, REFER TO THE PLUMBING DESIGN PLAN. FOR DATA DEVICE SCHEDULE, REFER TO THE ELECTRICAL DESIGN PLAN

G. SEE SHEET I-601 FOR SCHEDULES.

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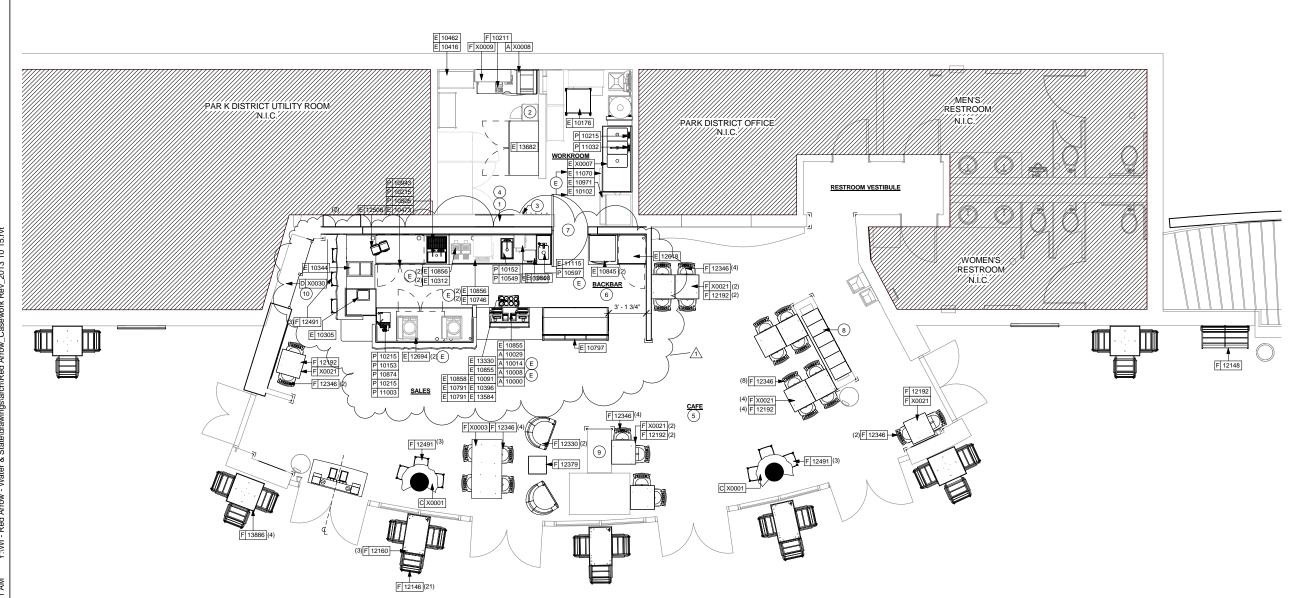
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SHEET TITLE

FF AND E PLAN

SCALE:



1) FURNITURE, FIXTURES, AND EQUIPMENT PLAN

1. DO NOT CAULK TRASH RINGS TO COUNTERTOPS.

2. INSTALL CHAIR RAIL THROUGHOUT AS INDICATED. SEE INTERIOR ELEVATION SHEETS FOR CLARIFICATION.

3. INSTALL CONDIMENT CART AS INDICATED.

4. INSTALL UPPER CUBBIES WITH FRENCH CLEAT AND VALANCE AS INDICATED. RETURN LIGHT VALANCE TO WALL AT OPEN CUBBY ENDS.

5. GC TO MODIFY CABINET BASE AS REQUIRED TO ALLOW ACCESS TO FLOOR DRAIN/SINK.

6. GC TO SEAL ALL EXPOSED WOOD EDGES OF THE CABINETS & COUNTERTOPS FOR HORIZONTAL AND VERTICAL EDGES.

7. REFER TO CASEWORK DETAIL SHEETS FOR ADDITIONAL INFORMATION.

8. RETURN VALANCE TO BACK WALL AT END.

9. FULL HEIGHT WOOD CLADDING - WD0037

10. NEW WOOD TOP AND BRACKETS BY CASEWORK VENDOR.

11. WOOD CLADDING ABOVE LOCKERS.

12. STRIP AND RESTAIN RESTROOM DOORS TO MATCH WD0001

CASEWORK PLAN NOTES

A. GENERAL CONTRACTOR TO NOTIFY STARBUCKS CONSTRUCTION MANAGER IMMEDIATELY IF A DISCREPANOY EXISTS BETWEEN CASEWORK SHOP DRAWINGS, SITE DIMENSIONS, CASEWORK PLAN OR ACTUAL CASEWORK FIXTRES. ALL DIMENSIONS TO BE TAKEN FROM DESIGNATED DATUM POINT.

B. STARBUCKS CONSTRUCTION MANAGER TO COORDINATE AND SCHEDULE CASEWORK DELIVERY DATE. GENERAL CONTRACTOR TO CONFIRM CASEWORK DELIVERY DATE WITH CASEWORK MANUFACTURER 4 WEEKS AND 1 WEEK PRIOR TO SCHEDULED DATE OF DELIVERY.

C. STARBUCKS CONTRACTS DIRECTLY WITH CASEWORK VENDOR TO SUPPLY CASEWORK LISTED IN CASEWORK SCHEDULE, UNLESS OTHERWISE NOTED.

D. REFER TO CASEWORK INSTALLATION MANUAL PROVIDED BY CASEWORK VENDOR FOR COMPLETE INSTALLATION INSTRUCTIONS.

E. ALL CASEWORK BASE UNITS SHALL BE SET ON $1/4^{\circ}$ (6MM) NON-ABSORBENT PLASTIC SHIMS PROVIDED BY CASEWORK VENDOR.

F. SEE WALL FINISH PLAN FOR LOCATION, TAGGING, AND FINISH SCHEDULES OF APPLIED WALL TREATMENTS.

G. INSTALL OVEN STAINLESS STEEL COUNTERTOP AND BASE CABINET WITH 1/2" (10MM) GAP BETWEEN ADJACENT COUNTERTOPS.

H. SEE REFLECTED CEILING PLAN FOR CASEWORK SOFFIT LOCATIONS.

J. SEE SCHEDULE SHEETS FOR SCHEDULES.

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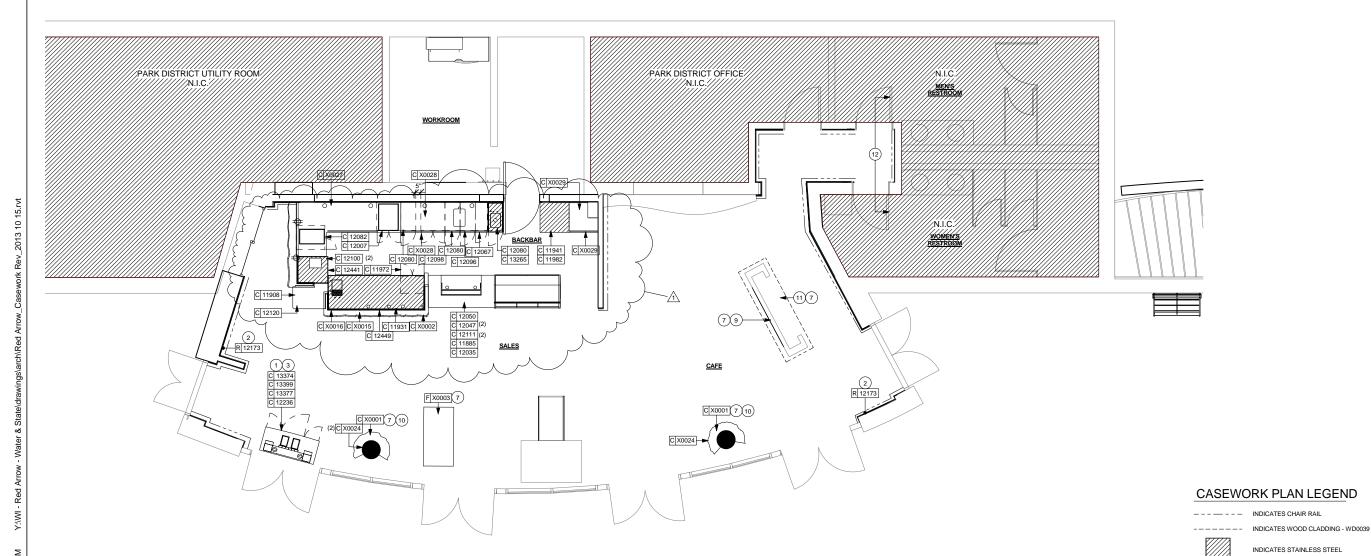
SHEET TITLE

CASEWORK PLAN

As indicated

SCALE:

SHEET NUMBER: I-1107




CASEWORK PLAN

2 TRACK LIGHTING - SUSPENDED MOUNT

Ceiling/Soffit support structure 5/8" Gyp Wall Board Lighting Fixture Track Attached to Ceiling Structure above gyp. w/#12x1 1/2" Panhead SH. MTL. Screws @ 2'-0" O.C.

Track Mounted to Gypsum Board Soffit

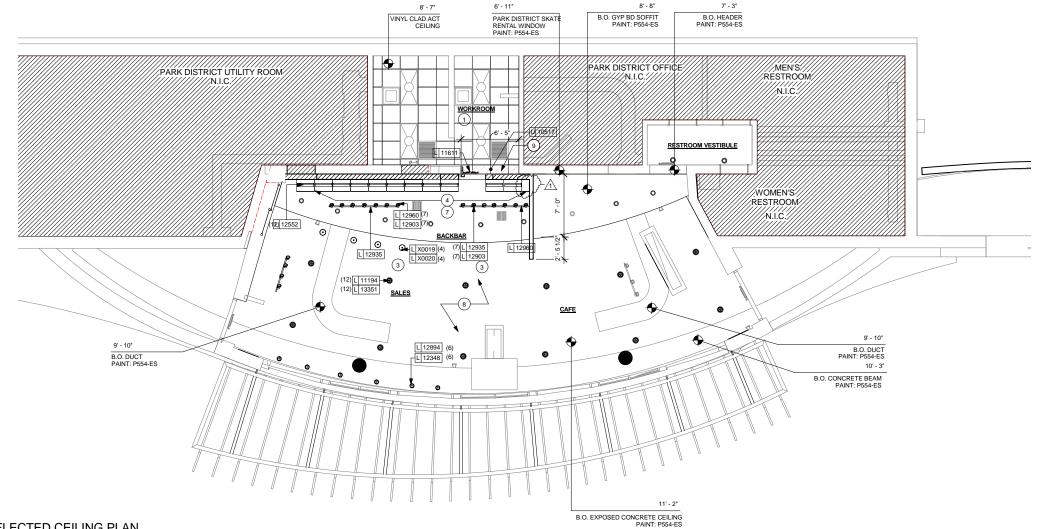

REFLECTED **CEILING PLAN NOTES**

A. IF REQUIRED BY LOCAL CODE, GENERAL CONTRACTOR TO PROVIDE SEMI-RECESSED SPRINKLER HEADS WITH POLISHED CHROME ESCUTCHEONS CENTERED IN ACOUSTICAL CEILING TILE. IF PENDANT HEADS ARE REQUIRED IN GYPSUM SOFFIT OVER FRONTBAR, CONCEAL SUPPLY PIPING WITHIN SOFFIT. GENERAL CONTRACTOR TO SUBMIT SPRINKLER LAYOUT TO STARBUCKS CONSTRUCTION MANAGER FOR APPROVAL PRIOR TO INSTALLATION.

B. GENERAL CONTRACTOR TO PROVIDE AND LOCATE SPRINKLERS PER LOCAL CODES. CONTACT STARBUCKS CONSTRUCTION MANAGER IF DESIGN INTENT IS AFFECTED.

C. WHERE ACOUSTICAL CEILING MEETS WALL, PROVIDE ANGLE WALL MOLDING FOR REVEAL. MATCH CEILING GRID COLOR WHEN APPLICABLE.

D. LEAVE (10) ADDITIONAL RETAIL CEILING TILES, TO MATCH RETAIL CEILING PAINT COLOR, ABOVE THE WORKROOM CEILING AT MANAGER'S DESK FOR FUTURE USE.

E. PROVIDE GROMMET AT ALL CEILING PENETRATIONS FOR FIXTURES OR SUPPORTS.

F. HEATING, VENTILATING, AND AIR CONDITIONING (HVAC) SHOWN FOR DESIGN INTENT ONLY. CONTACT PROJECT MANAGER IF CHANGED.

G. DIFFUSERS AND RETURNS AT BACKBAR IN ACOUSTICAL CEILING TILE TO BE CENTERED IN TILE, PAINTED TO MATCH ADJACENT FINISHES, TYPICAL.

H. PAINT ALL HVAC DUCTS, HVAC DIFFUSERS, RECESSED SPEAKERS AND LIGHT TRIM RINGS THE SAME COLOR AS CEILING OR SOFFIT. TYPICAL THROUGHOUT RETAIL PORTION OF STORE.

J. PAINT SUBSTITUTIONS ARE NOT ALLOWED. USE STARBUCKS' NATIONAL ACCOUNT "COLOR CODE" WHEN ORDERING PAINTS. SEE SCHEDULE SHEETS FOR SCHEDULES

K. SEE LIGHTING DESIGN PLAN FOR FIXTURE TYPES AND LOCATION DIMENSIONS.

SHEET NOTES

1. RETAIN EXISTING ACT IN WORKROOM. PATCH AND REPAIR AS NEEDED.

2. RETAIN GYP BOARD CEILING. EXTEND RADIUS OVER BACKBAR PATCH AND REPAIR AS NEEDED.

3. NEW 8' TRACK LIGHT AND TRACK HEADS.

4. NEW MENU BOARDS ATTACHED TO UPPER CUBBIES.

5. NEW PENDANTS AT FIREPLACE

6. NEW CAN PENDANTS. FLUSH MOUNTED.

7 NEW LIPPER CURRIES

8. GC TO PROVIDE HIGH DUSTING AND DUCT CLEANING INSIDE AND OUT.

9. GC TO INSTALL NEW VINYL CLAD ACT IN WORKROOM WHERE WALL HAS BEEN DEMOLISHED.



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SHEET TITLE

REFLECTED CEILING **PLAN** SCALE: As indicated

I-1108

REFLECTED CEILING PLAN

STAINLESS STEEL LEG AT CABINET

Scale: 3" = 1"·0"

Leveling substrate


- Floor

RUBBER FLOORING TX0004-TILE BASE

Schluter Schiene stainless steel transition edge strip installed flush with tile. Select edge strip height based on tile thickness. Install

6 Tile/Altro Transition

strip per manufacturer's

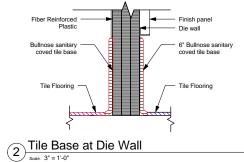

Tile Base at Outside Corner

Tile Flooring

Tile Base at Interior Wall

FLOOR FINISH PLAN NOTES

A. STARBUCKS TO SUPPLY RETAIL FLOOR TILE AND TILE BASE. GENERAL CONTRACTOR TO INSTALL. GENERAL CONTRACTOR TO INSTALL. GENERAL CONTRACTOR TO SUPPLY AND BASE AND INSTALL. GENERAL CONTRACTOR TO SUPPLY AND INSTALL MORTAR, ADHESIVE, AND GROUT. GENERAL CONTRACTOR TO INSPECT ALL TILES AND REJECT DAMAGED OR SUBSTANDARD TILES PRIOR TO INSTALLATION.

B. ALL TILE AND SLATE TO BE INSTALLED PER TILE COUNCIL OF AMERICA STANDARDS.

C. ALL FLOORING AND BASE MATERIAL TO BE INSTALLED ACCORDING TO STARBUCKS SPECIFICATIONS.

D. CABINET BASES TO BE SET AFTER TILE INSTALLATION. E. ALIGN TILE TRANSITIONS ON WHOLE TILES AS SHOWN.

F. FOR CARPET INSTALLATION, REFER TO MANUFACTURERS' INSTALLATION INSTRUCTIONS.

SHEET NOTES

1. REPLACE RUBBERIZED FLOORING THROUGHOUT CAFE.

3. INSTALL NEW TILE BASE THROUGHOUT AS INDICATED.

2. FLOOR SINK/FLOOR DRAIN LOCATION.

4. TILE GROUT JOINTS TO BE 1/8".

- EXISTIN TILE TO REMAIN MEN'S PAR K DISTRICT UTILITY ROOM ŔĔSTROÓM PARK DISTRICT OFFICE N.I.C./ NEW TILE & BASE WOMEN'S RESTROOM

SALES

BACKBAR

B 13101

FLOOR FINISH LEGEND

NEW RUBBER FLOORING TILES JOHNSONITE FLOORING: TRIUMPH SMH-743, MUDDY WATERS WG. SURFACE TEXTURE: HAMMERED, 24x24, 3/8" GAUGE

NEW 6X12 FLOOR TILE - GRAPHITE - DID 12203

EXISTING WORKROOM TILE FLOOR

NEW WORKROOM 12X12 TILE FLOOR -DIAMANTE - DID 11457

- · - · - TILE BASE GRAPHITE 6X12IN DESIGN ID: 13101







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SHEET TITLE

FLOOR FINISH PLAN

As indicated


I-1109

5 FLOOR FINISH PLAN

B 13101 3

TILE BASE

SCALE:

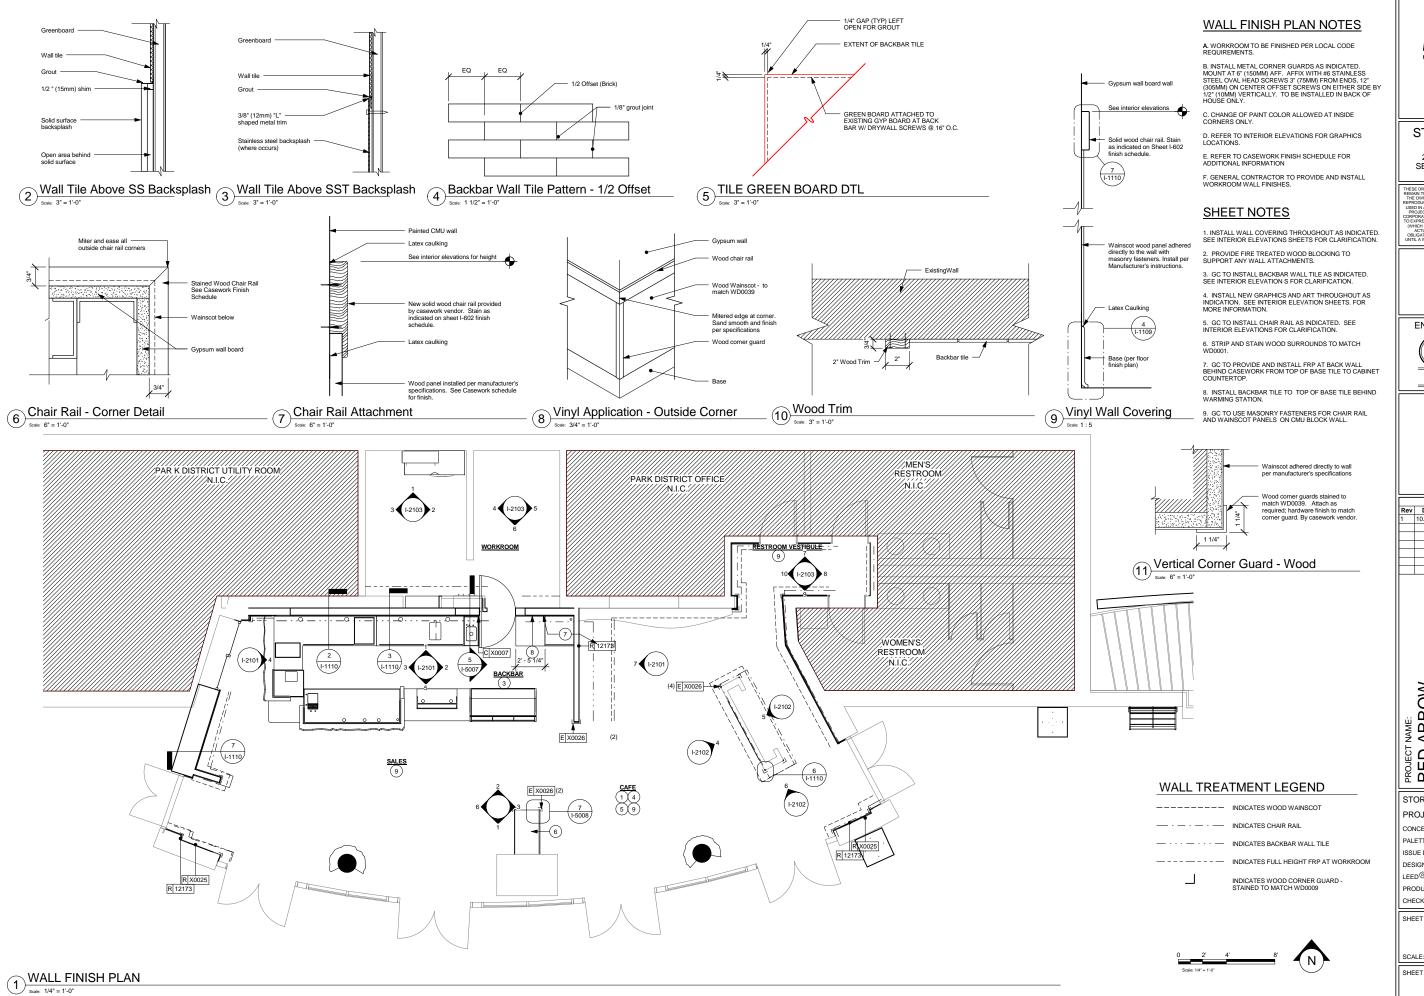

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ARROW PROJECT |

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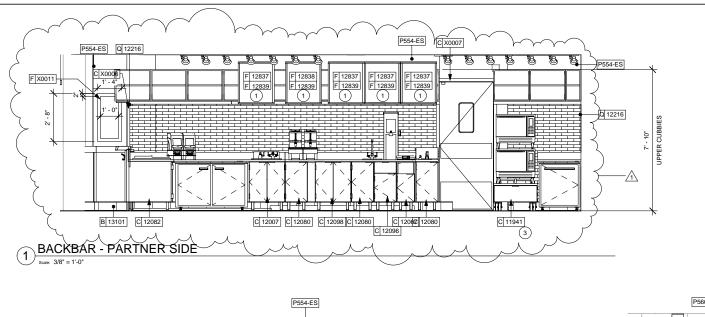
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SHEET TITLE

WALL FINISH PLAN

As indicated



SHEET NOTES

- 1. ATTACH MENU HINGE TO TOP OF CABINET TO ALLOW ACCESS TO CABINET SHELVES BEHIND, TYPICAL.
- 2. APPLY FRP TO ALL SIDES OF CHASE INTERIOR BEHIND CUBBIE.
- 3. BACKBAR WALL TILE RUNS BEHIND WARMING STATION.
- 4. GC TO STRIP AND RESTAIN WOOD TO MATCH WD0001
- 5. INSTALL MESH PANEL PER MANUFACTURER'S INSTRUCTIONS.
- 6. GC TO STRIP AND RESTAIN DOORS TO MATCH WD0001.

INTERIOR ELEVATION NOTES

- A. REFER TO MANUFACTURERS' INSTRUCTIONS SHIPPED WITH ARTWORK FOR INSTALLATION INSTRUCTIONS AND SPACING.
- B. INSTALL WALL CABINETS BEFORE BACKBAR WALL TILE. RUN BACKBAR WALL TILE TO UNDERSIDE OF WALL CABINETS, NOT BEHIND CABINETS.
- C. PAINT SUBSTITUTIONS ARE NOT ALLOWED. USE STARBUCKS' NATIONAL ACCOUNT "COLOR CODE" WHEN ORDERING PAINTS.
- D. PAINT FINISHES SHALL BE APPLIED AS FOLLOWS, UNLESS OTHERWISE NOTED:

 ALL WOOD AND METAL SURFACES SHALL BE PAINTED SEMIGLOSS, OR EQUAL.

 ALL ACCENT AND TRIM PAINT TO BE SEMIGLOSS, OR EQUAL.
 ALL WALL AND CEILING PAINTS TO BE EGGSHELL, OR EQUAL.

- E. FOR PAINT, WALL TREATMENT, AND GRAPHICS SCHEDULES, REFER TO SCHEDULE SHEETS.



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ARROW PROJECT RED

STORE #: PROJECT #: 14516-022 CONCEPT:

PAI ETTE: HERITAGE S. RYCHLIK


LEED® AP:

PRODUCTION DESIGNER: C. ALINOVICH, NORR CHECKED BY K. GORIN. NORR

INTERIOR ELEVATIONS


SHEET NUMBER:

As indicated

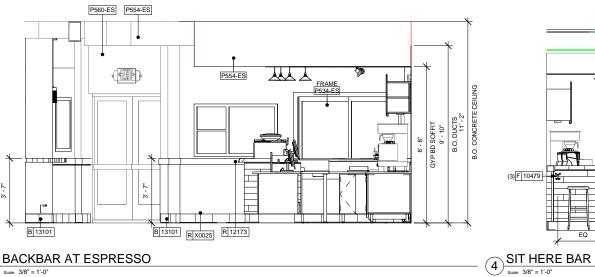

3 BACKBAR AT ESPRESSO

P554-ES

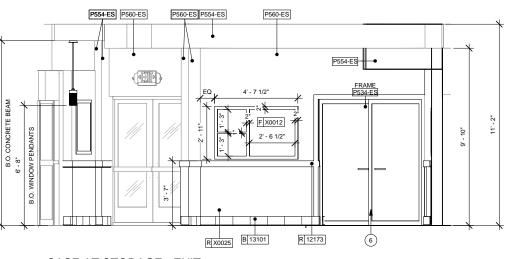

C 11908 C 11972 5' - 6" 5' - 6 1/4" 11' - 1 1/2" 66IN PASTRY CASE POS ESP

FRONTBAR - PARTNER SIDE

Scale: 3/8" = 1"-0"

2 BACKBAR AT WARMING STATION

Scale: 3/8" = 1'-0"

6 CASE AT STORAGE - EXIT

7 CAFE SEATING ADJACENT TO SKATE WINDOWS DESIGN MANAGER:

P554-ES

SHEET TITLE

SCALE:

I-2101

C X0028

C 12080



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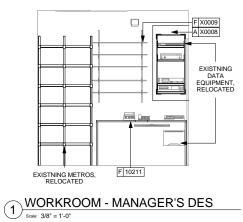
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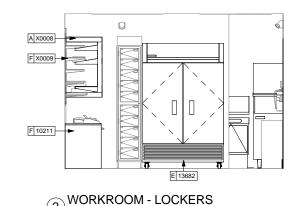
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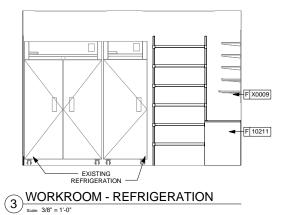
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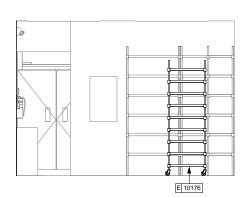
INTERIOR ELEVATIONS

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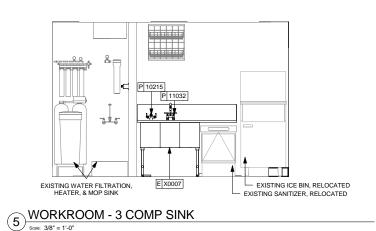









WORKROOM - STORAGE


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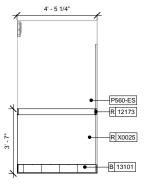




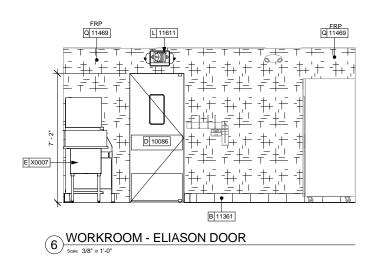

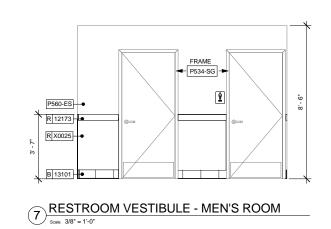

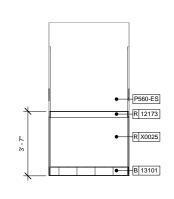

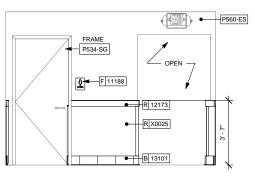

8 RESTROOM VESTIBULE - SOUTH WALL

Scale: 3/8" = 1'-0"



 $\underbrace{10}_{\text{Scale: 3/8"} = 1^{\circ} \cdot 0^{\circ}}^{\text{RESTROOM VESTIBULE - NORTH WALL}}$



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ARCHITECT OF RECORD

ENGINEER OF RECORD

W.(A) Engineering Consultant

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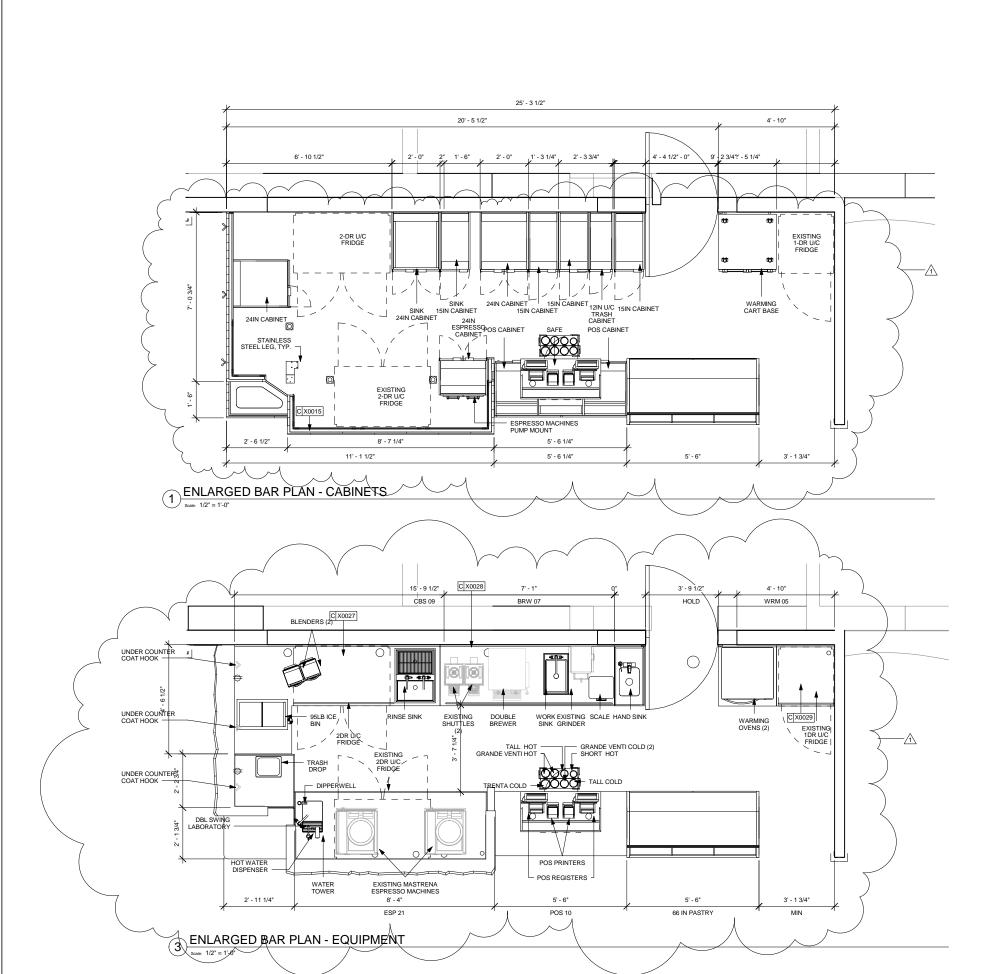
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SHEET TITLE:

SCALE:

INTERIOR ELEVATIONS

3/8" = 1'-0"





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ENGINEER OF RECORD **WA**)

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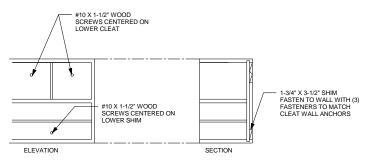
ENLARGED BAR PLANS

SCALE:

SHEET NUMBER:








NOTES:

1. 45 LBS DEAD LOAD PER OPENING FOR LIQUID STORAGE OVER AND


2. A LIVE LOAD OF A PARTNER EITHER PULLING AND OR CLIMBING ON THE CASEWORK.

BLOCKING TO CASEWORK


Scale: 1/2" = 1'-0"

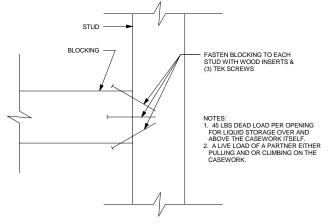


2 BLOCKING TO METAL STUD

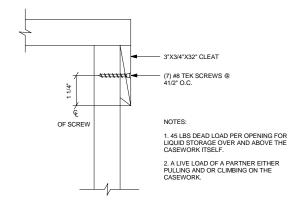


CLEAT TO FRAME

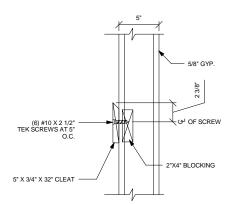


CLEAT TO WOOD BLOCKING Scale: 1/2" = 1'-0"

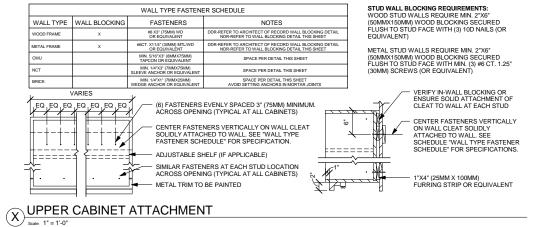


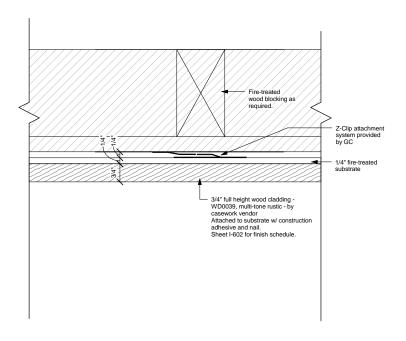


(6) Wood Cladding Attachment - Plan Dtl

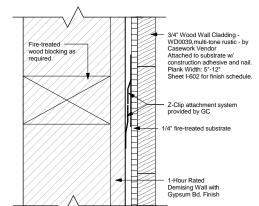

7 Wood Cladding Attachment - Section Dtl

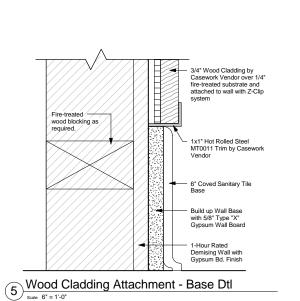

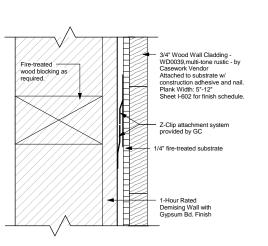

STARBUCKS COFFEE COMPANY
2401 UTAH AVENUE SOUTH SEATTLE, WASHINGTON 98134 (206) 318-1575

ARCHITECT OF RECORD

ENGINEER OF RECORD

Phone (314) 772-1782 Fax (314) 772-0108 Engineering Consultant

Description

PROJECT NAME:
RED ARROW
PROJECT ADDRESS:
920 WATER STREET
MILWAUKEE, WI 53202

STORE #: PROJECT #: 14516-022 CONCEPT: NCS PAI ETTE: HERITAGE ISSUE DATE: 10.17.13 DESIGN MANAGER: S. RYCHLIK LEED® AP:


PRODUCTION DESIGNER: C. ALINOVICH, NORR CHECKED BY K GORIN NORR

SHEET TITLE


SCALE:

CONSTRUCTION **DETAILS** As indicated


Architect to Coordinate with Licensee regarding San/Wash Equipment.

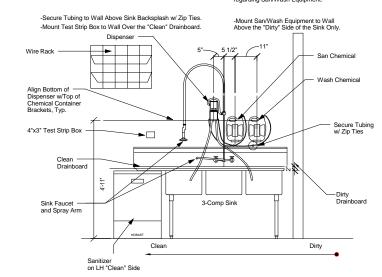


2 Click San/Wash Install (Sanitizer Below) -MIRROR - FOR REFERENCE ONLY

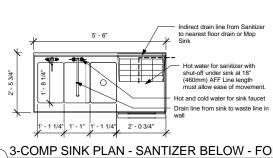

 $\underbrace{1}_{\text{Scale: }1/2"=1"\cdot 0"} \underbrace{\text{3-COMP SINK PLAN - SANTIZER BELOW - FOR REF. ONLY}}_{\text{Scale: }1/2"=1"\cdot 0"}$

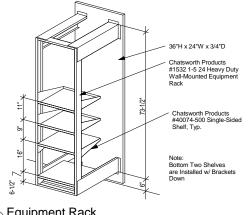

3 Equipment Rack

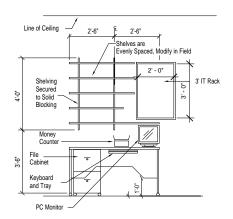

Managers Desk - FOR REFERENCE ONLY

Scale: 3/8" = 1'-0"



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PROJECT ADDRESS:
920 WATER STREET
MILWAUKEE, WI 53202

STORE #: PROJECT #: 14516-022 CONCEPT: NCS PALETTE: HERITAGE ISSUE DATE:

DESIGN MANAGER: S. RYCHLIK LEED®AP: PRODUCTION DESIGNER: C. ALINOVICH, NORR

CHECKED BY: K. GORIN. NORR

SHEET TITLE:


WORKROOM DETAILS


SCALE:


I-5003

As indicated




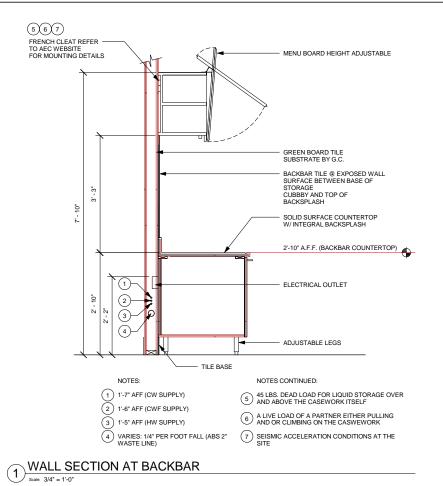

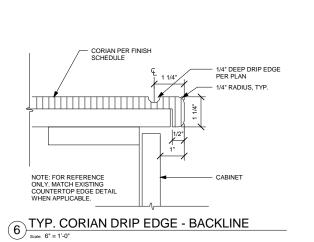


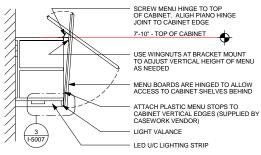


2 CASEWORK MENU MOUNTING SECTION
Scale: 3/4" = 1'-0"

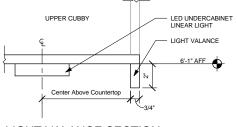




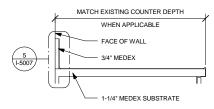



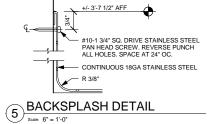

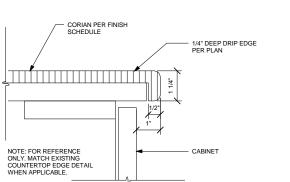





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Descriptio

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STORE #: PROJECT #: 14516-022 CONCEPT: NCS PALETTE: HERITAGE ISSUE DATE:

DESIGN MANAGER: S. RYCHLIK LEED® AP:


PRODUCTION DESIGNER: C. ALINOVICH, NORR CHECKED BY K. GORIN. NORR


SHEET TITLE

CASEWORK DETAILS

As indicated

SCALE:

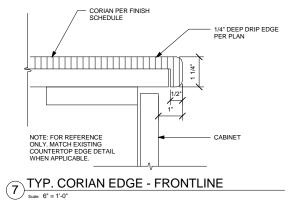

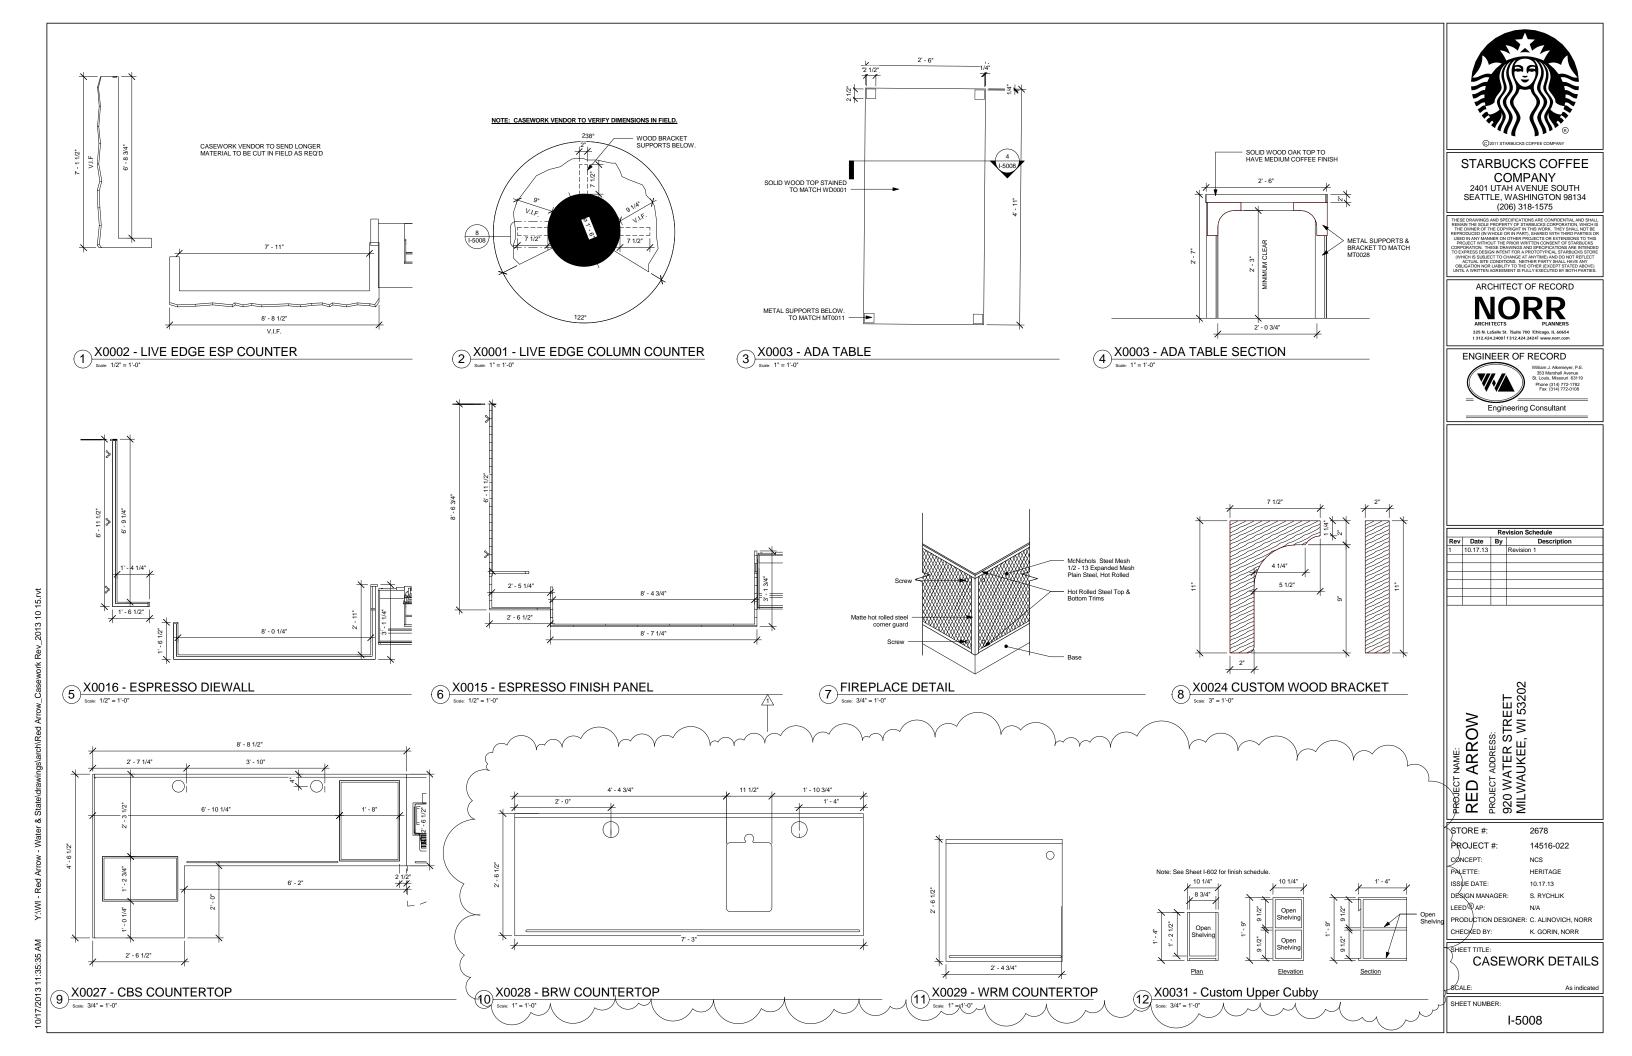

		SPECIALTY EQUIPMENT SCHE		
DESIGN ID	COUNT	DESCRIPTION	RESP.	COMMENTS
X0007	1	Custom Sink - 3 Comp Work SST - RH - 66in	WH	Elkay
COOLING				
10473	1	FRIDGE UNDERCOUNTER 2 DOOR - 48IN 1220MM	3PL	ENERGY STAR COMPLIANT
12618	1	FRIDGE UNDERCOUNTER 1 DOOR WITH SHELF - 27IN 685MM	3PL	ENERGY STAR COMPLIANT
13682	1	FREEZER REACH IN 2 DOOR - 54IN 1370MM	3PL	ENERGY STAR COMPLIANT
EQUIPMENT			•	
10845	2	OVEN TURBOCHEF CONVECTION MICROWAVE	VD	TURBOCHEF
12508	2	BLENDER QUIET MODEL ON COUNTER	VD	VITAMIX
FOOD CASE				
10797	1	FOOD CASE - STACKED - 66IN 1675MM - BRONZE	3PL	
ICE		•		•
10344	1	ICE - BIN DROP IN 90LB 40KG	3PL	
OTHER		•		
10091	1	CUP DISPENSER TALL HOT VERTICAL	3PL	
10305	1	TRASH DROP RING LINER SQUARE - BLACK	3PL	
10314	1	SCALE DIGITAL WITH ADJUSTABLE DISPLAY MOUNT	WH	
10396	1	CUP DISPENSER SHORT HOT VERTICAL	3PL	
10791	2	CUP DISPENSER GRANDE VENTI COLD VERTICAL	3PL	
10855	2	CUP DISPENSER GRANDE VENTI HOT VERTICAL	3PL	
10858	1	CUP DISPENSER TALL COLD VERTICAL	3PL	
11115	1	SOAP DISPENSER SINK MOUNTED	3PL	
13330	1	MOBILE CUP DISPENSER CADDY	3PL	
13584	1	CUP DISPENSER TRENTA COLD VERTICAL	3PL	
X0026	18	CORNER GUARD - 1.25IN 30MM - PEWTER	VD	WOOD CORNER GUARD STAINED TO MATCH WAINSCOT PANEL (WD0039). BY CASEWORK VENDOR. SEE INTERIOR ELEVATIONS FOR HEIGHTS AND LOCATION
STORAGE				
10176	1	ROLLING PASTRY TRAY RACK	3PL	

	FURNITURE SCHEDULE - "F"							
DESIGN ID	COUNT	DESCRIPTION	RESP.	COMMENTS				
BENCH		·						
12148	2	BENCH - SLATTED METAL SUITE - BLACK MT0028	VD					
CHAIR		•	•					
12146	21	CHAIR - CAFE SLATTED METAL SUITE WITH ARMS - BLACK MT0028	3PL					
12330	2	CHAIR - LOUNGE BARREL BACK - BRICK RED NATURAL F0017	3PL					
12346	24	CHAIR - CAFE SCHOOLHOUSE - DISTRESSED DARK WARM BROWN WD0001	3PL					
12491	9	CHAIR - STOOL 29IN 735MM INDUSTRIAL UPHOLSTERED - BRICK RED NATURAL F0017	3PL					
DESK			*					
10211	1	DESK - MANAGERS WORKSTATION SMALL - 60X24X30IN 1525X610X760MM - ALMOND LAMINATE	3PL	MODIFY SHELVES IN FIELD.				
OTHER		•	•					
10479	3	COAT HOOK 2 PRONG	WH					
TABLE		•	•					
12160	3	TABLE - ACCESSIBLE METAL SUITE - 39X23IN 990X585MM - BLACK MT0028	3PL					
12192	10	TABLE - BASE COCKTAIL DOME ACCENT - 12X25IN 305X635MM - HOT ROLLED STEEL MT0011	3PL					
12379	1	TABLE - OCCASIONAL X BASE - AGED DARK BROWN CM0001	3PL					
13886	4	TABLE - CAFE METAL SUITE SQUARE - 30IN 760MM - DARK OLIVE BROWN MT0036	3PL					
X0003 1 TABLE - ACCESSIBLE		VD	BY ICON MODERN. SOLID WOOD TOF WITH MEDIUM COFFEE FINISH ON OAK. METAL SUPPORTS AND BRACKETS TO MATCH MT0028. ADA ACCESSIBLE TABLE. SEE CASEWORN DETAIL SHEET FOR FURTHER INFORMATION.					
X0021	10	TABLE - TOP SQUARE - 24IN	VD	PROVIDED BY ICON MODERN, MEDIU COFFEE FINISH, OAK. ROCKY@ICONMODERN.COM P: 312.560.2067				

		GRAPHICS SCHEDULE -	· "G"	
DESIGN ID	COUNT	DESCRIPTION	RESP.	COMMENTS
GRAPHICS -	INTERIOR	MENU		
12837	4	MENU BOARD - 1 FRONT PANEL INSERT STYLE	VD	
12838	1	MENU BOARD - DAILY OFFERING CHALKBOARD FRONT PANEL RECTANGULAR	VD	
12839	5	MENU BOARD - UNIVERSAL MOUNTING HARDWARE FOR FRONT PANELS	VD	
X0010	1	MURAL AT WOOD CLAD WALL	VD	BY GFX. 5'7" x 3'5". 2" WOOD FRAME STAINED TO MATCH WD0001. IMAGE: NS0144
X0011	1	ART AT SIT HERE BAR	VD	BY GFX. 1'4" x 2'8". 2" WOOD FRAME STAINED TO MATCH WD0001. IMAGE: NS00186
X0012	1	COMMUNITY BOARD WITH COFFEE IMAGES	VD	COMMUNITY BOARD COFFEE IMAGES: NS 0204 & NS 0201. 2IN OUTER WOOD FRAME WITH 1IN INSIDE TRIM PIECES ALL STAINED TO MATCH WD0001. SEE INTERIOR ELEVATIONS FOR MORE INFORMATION.
X0013	1	LOCAL RELEVANCE ART	VD	BY GFX. 2:3"x3". 2"WOOD TRIM STAINED TO MATCH WD0001. LOCAL RELEVANCE ART TO BE COORDINATED WITH DESIGN MANAGER. SEE INTERIOR ELEVATIONS FOR MORE INFORMATION
X0014	1	LOCAL RELEVANCE ART	VD	BY GFX. 2:3" x.3". 2" WOOD TRIM STAINED TO MATCH WD0001. LOCAL RELEVANCE ART TO BE COORDINATED WITH DESIGN MANAGER. SEE INTERIOR ELEVATIONS FOR MORE INFORMATION
GRAPHICS -	OTHER			
11188	1	RESTROOM SIGN WOMEN	VD	
11243	1	RESTROOM SIGN MEN	VD	

DESIGN ID	COUNT	DESCRIPTION	RESP.	COMMENTS
DRAIN				
10309	5	DRAIN - FLOOR SINK WITH HALF GRATE SQUARE - 12IN 305MM	GC	GC TO PROVIDE. SEE PLUMBING DRAWINGS FOR MORE INFORMATION.
FAUCET				
10152	1	FAUCET - DOUBLE LABORATORY WITH BENT RISER SPOUT	GC	
10153	1	FAUCET - WATER TOWER - 12IN 305MM	3PL	
10215	3	FAUCET - DOUBLE LABORATORY WITH SWING SPOUT	3PL	
10597	1	FAUCET - SINGLE HANDLE	3PL	
10874	1	FAUCET - HOT WATER DISPENSER GOOSENECK	3PL	
10943	1	FAUCET - SINGLE LABORATORY WITH SWING SPOUT	3PL	
11003	1	FAUCET - DIPPERWELL	3PL	
11032	1	FAUCET - DOUBLE JOINTED SWING SPOUT	3PL	
SINK				
10505	1	SINK - RINSE DROP IN - 27X20IN 685X510MM	3PL	
10549	1	SINK - RINSE DROP IN SST - 12X20IN 305X510MM	3PL	
$\overline{}$	$\overline{}$	DOOR SCHEDULE - "D)"	

PLUMBING FIXTURE SCHEDULE - "P"

COMMENTS

DECION ID COUNT

<u></u>	DESIGN ID	COUNT	DOOR SCHEDULE . " DESCRIPTION	D" RESP.	COMMENTS
٠ > ك	X0030	1	COMMERCIAL GRADE BYPASS DOOR	GCVD	COMMERCIAL GRADE SLIDING BYPASS DOOR WITH ALUMINIUM TRACK AND FASCIA, 2-DR CONFIGURATION, MODEL 138F. DOOR THICKNESS: 1-3/8". BRONZE ANODIZED TACK AND HARDWARE. STAIN TO MATCH WD0001. JOHNSON HARDWARE. WWW.JOHNSONHARDWARE.COM. T: 800.837.5664. INFO 8J.0PINSONHARDWARE.COM. J J
	DOOR 10086	1	DOOR - SINGLE IMPACT DOUBLE ACTING - 36IN 915MM	VD VD	LOCKNET. ELIASON DOOR WITH HARDWARE. FINISH WILSONART PL0014 - MONTANA WALNUT.

	SIGNAGE SCHEDULE - "S"							
DESIGN ID	DESIGN ID COUNT DESCRIPTION RESP. BULB COMMENTS							
SIGNAGE - I	SIGNAGE - DISK							
13163	2	SIGN - DISK SF ILLUMINATED FLUSH MOUNTED EVOLVED - 48IN 1220MM	SB		BY HILTON DISPLAYS. TRACIE GESEL. 864.233.0401. TRACIEGESEL@HILTONDISPLAYS.COM			

		L	GHTING FIX	TURE SCHEDULE - "	L"	
DESIGN ID	COUNT	DESCRIPTION	RESP.	BULB	MAX WATTAGE	COMMENTS
CAN			•		•	
11194	12	CAN - SURFACE MOUNTED TALL - 6IN 150MM - BLACK	VD	(1) 13351 - LED PAR 30 10-19W FLOOD		PROVIDED BY CED
LAMP			•		•	
12894	6	INCAND EDISON T9 30W BEACON FILAMENT	VD			PROVIDED BY CED
12903	14	LED PAR 30S 10-19W NFL	VD			PROVIDED BY CED
13351	12	LED PAR 30L 10-19W FLOOD	VD			PROVIDED BY CED
X0020	4	1910 SQUIRREL-CASE FILAMENT BULB	VD		40W	PROVIDED BY CED. RESTORATION HARDWARE: 1910 SQUIRREL CAGE FILAMENT BULB. ITEM # 68260003
PENDANT			•			
12348	6	PENDANT - SMALL METAL MESH CYLINDER - BLACKENED STEEL MT0019	SB	(1) 12894 - INCAND T9 EDISON 30-39W		PROVIDED BY CED. SURFACE MOUNTED.
X0019	4	PENDANT - REFLECTOR PENDANT	VD	(1) 12885 - CFL G30 10-19W		PROVIDED BY CED. MANUFACTURER: RESTORATION HARDWARE. REFLECTOR FILAMENT 11" PENDANT. FINISH: AGED STEEL. DIMS: 11" DIAM, 6 3/4" HEIGHT. ITEM# 68060510 ASTL
STRIP		'				•
12552	11	TASK LIGHT INTEGRATED LED - 22IN 560MM - BLACK	VD	(6) INTEGRAL LED 1W		PROVIDED BY CED
TRACK			•	•	•	•
12935	2	TRACK - WITH CONNECTORS - 8FT 244CM - WHITE	VD			PROVIDED BY CED
12946	1	TRACK - WITH CONNECTORS - 4FT 122CM - BLACK	VD			PROVIDED BY CED
12960	14	TRACK - FIXTURE OPEN FLARED - 5IN 125MM - WHITE	VD	(1) 12903 - LED PAR 30S 10-19W NARROW FLOOD		PROVIDED BY CED

D: ID		to be Relocated -		
Design ID	Count	Description	Category	Comments
Data Devices				1
10008	2	REGISTER COMPACT	Data Devices	EXISTING ITEM TO BE RELOCATED
10014	2	POS PRINTER	Data Devices	EXISTING ITEM TO BE RELOCATED
ighting Fixtures				
12561	11	CAN - RECESSED HOUSING - 5IN 125MM - EXISTING CEILING	Lighting Fixtures	EXISTING ITEM TO BE RELOCATED
Specialty Equipn	nent			
10102	1	ICE - BIN 590LB	Specialty Equipment	EXISTING ITEM TO BE RELOCATED
10312	2	BREWER SINGLE SOFT HEAT WARMING STAND	Specialty Equipment	EXISTING ITEM TO BE RELOCATED
10416	9	WORKROOM WIRE SHELVING	Specialty Equipment	EXISTING ITEM TO BE RELOCATED
10462	9	WORKROOM WIRE SHELVING POSTS	Specialty Equipment	EXISTING ITEM TO BE RELOCATED
10746	1	BREWER DUAL SOFT HEAT	Specialty Equipment	EXISTING ITEM TO BE RELOCATED
10856	2	BREWER SERVER SOFT HEAT	Specialty Equipment	EXISTING ITEM TO BE RELOCATED
10971	1	ICE - MACHINE 625LB AIR COOLED SIDE VENT	Specialty Equipment	EXISTING ITEM TO BE RELOCATED
11014	1	FREEZER REACH IN 1 DOOR LH - 29IN 735MM	Specialty Equipment	EXISTING ITEM TO BE RELOCATED
11070	1	Dishwasher Sanitizer	Specialty Equipment	EXISTING ITEM TO BE RELOCATED
11083	1	FRIDGE REACH IN 2 DOOR - 51X35IN 1295X890MM	Specialty Equipment	EXISTING ITEM TO BE RELOCATED
12694	2	ESPRESSO MACHINE MASTRENA	Specialty Equipment	EXISTING ITEM TO BE RELOCATED

RESPONSIBILITY LEGEND

SB - STARBUCKS

GC - GENERAL CONTRACTOR

VD - VENDOR

LL - LANDLORD



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PROJECT ADDRESS:
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MILWAUKEE, WI 53202

STORE #: PROJECT #: 14516-022 CONCEPT: NCS PALETTE: HERITAGE

ISSUE DATE: 10.17.13 DESIGN MANAGER: S. RYCHLIK LEED® AP:

PRODUCTION DESIGNER: C. ALINOVICH, NORR CHECKED BY: K. GORIN. NORR

SHEET TITLE:

SCHEDULES

SCALE:

SHEET NUMBER:

PAINT SCHEDULE								
COLOR CODE	DESCRIPTION	LRV	RESP.	COMMENTS				
P534-SG	SW- P534 BLACK FOX - SEMI GLOSS	8	GC	DOOR FRAMES. SHERWIN WILLIAMS BLACK FOX SW7020 - USE PRIMER CP-1. SEE INTERIOR ELEVATIONS.				
P554-ES	SW - P554 INTELLECTUAL GREY- EGGSHELL	36	GC	FIELD PAINT AND CEILINGS. SHERWIN WILLIAMS INTELLECTUAL GREY SW7045; USE PRIMER CP-1. SEE INTERIOR ELEVATIONS				
P560-ES	SW- P560 ROYCROFT PEWTER - EGGSHELL	7	GC	ACCENT WALLS. SHERWIN WILLIAMS ROYCROFT PEWTER: SW2848 - USECP-1 PRIMERSEE INTERIOR ELEVATIONS				

	WALL BASE SCHEDULE - "B"				
DESIGN ID	LENGTH	DESCRIPTION	RESP.	COMMENTS	
TILE BASE					
11361	15' - 2 3/4"	TILE BASE - BIANCO - 6X12IN 150X305MM	VD	GROUT: MAPEI 09 - GRAY	
13101	244' - 11 1/2"	TILE BASE - GRAPHITE - 6X12IN 150X305MM		GROUT GR0007: MAPEI 47 - CHARCOAL USE WITH OUTSIDE CORNER TILE 12300	

	WALL TREATMENT (AREA) SCHEDULE - "Q"				
DESIGN ID	AREA	DESCRIPTION	RESP.	COMMENTS	
Ceramic					
12216	154 SF	Tile -Antique Cream 2" x 8"		Ceramic Backbar Tile. Grout Specification Mapei - 02 Pewter	
Plastic					
11469	215 SF	FRP - White	GC	MARLITE. STANDARD FRP. SMOOTH SURFACE. WHITE	

		WALL TREATMENT (LENGTH)	CHEDUL	E- "R"
DESIGN ID	LENGTH	DESCRIPTION	RESP.	COMMENTS
12173	96' - 7 3/4"	Chair Rail - 4in 100mm	VD	See Casework Finish Schedule for Material
X0025	83' - 9 1/2"	WOOD WAINSCOT PANEL -	VD	WOOD WAINSCOT PANEL STAINED TO MATCH WD0039. SEE INTERIOR ELEVATIONS FOR HEIGHT. BY CASEWORK VENDOR
TILE BASE				
11361	15' - 2 3/4"	TILE BASE - BIANCO - 6X12IN 150X305MM	VD	GROUT: MAPEI 09 - GRAY
13101	244' - 11 1/2"	TILE BASE - GRAPHITE - 6X12IN 150X305MM	VD	GROUT GR0007: MAPEI 47 - CHARCOAL USE WITH OUTSIDE CORNER TILE 12300
WAINSCOT				
X0023	9' - 8 1/4"	MESH PANEL AT FIREPLACE	VD	McNICHOLS STEEL MESH, 1/2 - 13 EXPANDED MESH. PLAIN STEEL HOT ROLLED. ITEM # 4800121348. WWW.MCNICHOLS.COM. 877.884.4653

	FLOOR TREATMENT SCHEDULE - "T"				
DESIGN ID	AREA	DESCRIPTION	RESP.	COMMENTS	
FLOOR					
11457	203 SF	Tile - Diamante - 12x12	VD	GROUT- MAPEI 09 - GREY.ASSOCIATED IMPORTS, DIAMANTE, NATURAL FINISH 12X12	
X0004	1032 SF	RUBBER FLOOR TILE - 24'x24"	GC	JOHNSONITE FLOORING. TRIUMPH, SMH-743, MUDDY WATERS WG. SURFACE TEXTURE: HAMMERED. TILE SIZE:24' x 24'. THICKNESS: 18''. INSTALL PER MANUFACTURER'S INSTRUCTIONS. WWW.JOHNSONITE.COM. 800.899.8916 16910 MUNN ROAD, CHAGRIN FALLS, OHIO 44023	

		CEILING TREATMENT SC	HEDULE - "U"	
DESIGN ID	AREA	DESCRIPTION	RESP.	COMMENTS
CEILING				
10517	19 SF	ACT - WHITE - 2X2FT 61X61CM	GC	VINYL CLAD ACT CEILING. REPAIR CEILING IN WORKROOM AS NEEDED

DESIGN ID	COLINIT	CASEWORK SCHEDULE DESCRIPTION	RESP.	COMMENTS		
DESIGN ID	COUNT	DESCRIPTION	RESP.	COMMENTS		
X0001 1 COUNTERS AT COLUMNS VI		1 COUNTERS AT COLUMNS VD		1 COUNTERS AT COLUMNS VD		CUSTOM WOOD BAR HEIGHT COUNTERTOPS AT COLUMNS. LIVE EDGE. STAINED TO MATCH WD0001
X0006	2 VERTICAL TRIM AT BACKBAR V		VD	2IN VERTICAL WOOD TRIM AT BACKBAR. TOTAL LENGTH NEEDED: 10' 4". STAINED TO MATCH WD0001		
X0007	1	WOOD TRIM AT ELIASON DOOR	VD	2IN WOOD TRIM STAINED TO MATCH WD0001		
CABINET		•	•	•		
11941	1	CABINET - WARMING CART BASE	VD			
11972	1	CABINET - ESPRESSO - 24IN 610MM	VD			
11977	11	CABINET - UPPER CUBBY - 24X16X21IN 610X405X535MM	VD			
12007	1	CABINET - SINK OR ICE BIN - 24IN 610MM	VD			
12050	1	CABINET - POS BRIDGE FOR SAFE - 22X27IN 560X685MM	VD			
12067	1	CABINET - WARMING WITH TRASH DROP - 12IN 305MM	VD			
12080	3	CABINET - 15IN 380MM	VD			
12082	1	CABINET - CBS ICE BIN - LH - 24IN 610MM	VD			
12096	. 1 _	CABINET - WITH DRAWER - 15HL 380MM	Mb /	h		
12098	V	CABINET - BREW GRIND - 24IN 610MM	VD/			
12111	2	CABINET - BREW GRIND - 24IN 610MM CABINET - POS - 22IN 560MM	VD	T		
x0031	1	CABINET - UPPER CUBBY	VD	CUSTOM WIDTH: 10 1/4"		
CAFE		12 0	1.5	1000.000.000.000.00		
12236	1,1	CONDIMENT CARTASIMOLE TOP SOLIDA	VOL	M		
13374	1	CONDIMENT CART SINGLE BASE FRAME	VD	NOT PROVIDED BY CASEWORK VENDOR		
13377	1	CONDIMENT CART SINGLE FINISH PANELS	VD			
13399	1	CONDIMENT CART SINGLE METAL TOP	VD	NOT PROVIDED BY CASEWORK		
		ASSEMBLY		VENDOR		
COUNTERTO)P	•		•		
11931	1	COUNTERTOP - ESPRESSO RINSE SINK STAINLESS - LH - 126 OR 137IN 3200 OR 3480MM	VD			
11982	1	COUNTERTOP - WARMING WITH FRONT BUMPER STAINLESS - 29IN 735MM	VD			
12035	1	COUNTERTOP - POS SOLID SURFACE - 66IN 1675MM	VD			
12120	1	COUNTERTOP - HANDOFF SOLID SURFACE - LH - 30X35IN 760X890MM	VD			
12441	1	COUNTERTOP - ESPRESSO WING ICE BIN STAINLESS - LH COUNTERTOP - HAND SINK LOW SPLASH	VD VD			
X0027	1	STAINLESS - 15IN 380MM COUNTERTOP - CBS SOLID SURFACE - LH :	VD			
X0027 X0028	1	105X48HN-2655X1215MM COUNTERTOP - BREW GRIND RINGE SINK AND	VD			
X0028 X0029	γ ^τ	TRASH SOLID SURFACE - LH - 93IN 2360MM COUNTERTOP - WARMING SOLID SURFACE -	VD	Y . Y . ,		
DIEWALL	' '	42IN 1065MM				
11908	-	DIEWALL HANDOFF SUPPORT - LH - 31X19IN	M			
7	ノ・	795X490MM	-			
X0002	1	DIEWALL - ESPRESSO TOP CAP - LH - 137IN 3480MM	VD	WISCONSIN BUILT. STAINED TO MATCH WD0001. SEE CASEWORK DETAIL SHEET FOR FURTHER INFORMATION.		
X0016 OTHER	1	DIEWALL - ESPRESSO - LH - 137IN 3480MM	VD			
10193	1	FRENCH CLEAT - 96IN 2440MM	VD			
11142	1	CORBEL SUPPORT - 24IN 610MM	VD			
11155	2	ESPRESSO MACHINE PUMP MOUNT - 10X10IN 255X255MM	VD			
11885	1	POS CASH CORRAL DOUBLE - 40IN 1015MM	VD	OPTIONAL CASH CORRAL. DESIGN TO VERIFY IF REQUIRED.		
12100	4	ESPRESSO COUNTERTOP SUPPORT LEG STAINLESS	VD			
12449	1	ESPRESSO SNEEZE GUARD - 137IN 3480MM	VD			
12816	2	FRENCH CLEAT - VARIABLE TO 96IN 2440MM	VD	DESIGNER TO VERIFY QUANTITY. PROVIDE OVERALL LENGTH REQUIRED		
X0024	4 SUPPORT BRACKET FOR COLUMN COUNTERS V		VD	WOOD SUPPORT BRACKET AT LIVE EDGE COLUMN COUNTERS. VERIFY PER FINAL COUNTERTOP DIMENSION. STAIN TO MATCH WD0001.		
PANEL						
12047	2	PANEL - POS - 33IN 840MM	VD			
	2	PANEL - POS - 33IN 840MM PANEL - ESPRESSO - LH - 137IN 3480MM	VD VD			

		FINISH	
LOCATION	DESCRIPTION	CODE	COMMENTS
WAINSCOT AT CAFE WALLS	WOOD WAINSCOT	WD0039	WAINSCOT PANELS AT CAF BY CASEWORK VENDOR. STAINED TO MATCH WD003
WOOD CLADDING AT LOCKER WALL	WOOD WALL CLADDING	WD0039	FULL HEIGHT WOOD WALL CLADDING, WD0039
CONCEPT FINISH	•		•
BACKBAR CASEWORK EXTERIOR	PLASTIC LAMINATE - MEDIUM TONE BROWN WITH GRAIN	PL0014	
BACKBAR COUNTERTOPS	COMPOSITE - GREY	CP0013	
BACKBAR STORAGE CUBBIES	PLASTIC LAMINATE - MEDIUM TONE BROWN WITH GRAIN	PL0014	
CHAIR RAIL	WOOD - WARM BROWN DARK TONE DISTRESSED	WD0001	
CONDIMENT CART TOP	COMPOSITE - GREY	CP0013	
CONDIMENT CART, ETAGERE, MERCH BAY EXTERIOR	PLASTIC LAMINATE - MEDIUM TONE BROWN WITH GRAIN	PL0014	
ESPRESSO COUNTERTOPS	STAINLESS STEEL - #4 BRUSHED 16GA SST	CP0013	
ESPRESSO COUNTERTOPS, HANDOFF	COMPOSITE - GREY	CP0013	
ESPRESSO FINISH PANELS	WOOD - RECLAIMED EASTERN MAPLE	X0022	WINDFALL LUMBER. TEXTI FLOORING, RECLAIMED EASTERN MAPLE, ORIGINA FINISH. WINDFALL LUMBE T: 360.352.2250. WWW.WINDFALLLUMBER.C
ESPRESSO TOP CAP/ESPRESSO TASTING COUNTER	WOOD - WARM BROWN DARK TONE DISTRESSED	WD0001	LIVE EDGE
ESPRESSO WING, HANDOFF FINISH PANELS	WOOD - RECLAIMED EASTERN MAPLE	X0022	WINDFALL LUMBER. TEXTI FLOORING, RECLAIMED EASTERN MAPLE, ORIGINA FINISH. WINDFALL LUMBE T: 360.352.2250. WWW.WINDFALLLUMBER.C
FINISH PANEL BRACKETS	HOT ROLLED STEEL	MT0011	
FINISH PANEL TRIM	HOT ROLLED STEEL WITH MATTE SEALER	MT0011	
POS, FRONTBAR COUNTERTOPS	COMPOSITE - GREY	CP0013	
POS, FRONTBAR, POS CASH CORRAL FINISH PANELS	WOOD - RECLAIMED EASTERN MAPLE	X0022	WINDFALL LUMBER. TEXTI FLOORING, RECLAIMED EASTERN MAPLE, ORIGINA FINISH. WINDFALL LUMBE T: 360.352.2250. WWW.WINDFALLLUMBER.C
MISCELLANEOUS FINISH	•		•
CORE CASEWORK INTERIOR	PLASTIC LAMINATE - ALMOND (ST655-S)		
ESPRESSO, CUSTOMER BAR SNEEZE GUARD	TEMPERED GLASS		
ESPRESSO, CUSTOMER BAR SNEEZE GUARD HARDWARE	STAINLESS STEEL - #4 BRUSHED 16GA SST		
ESPRESSO, POS, FRONTBAR CABINET BACK	PLASTIC LAMINATE - BLACK		
HAND SINK COUNTERTOP	STAINLESS STEEL - #4 BRUSHED 16GA SST		
OVER "BLACK" DUPLEX OUTLETS IN WAINSCOT LOCATIONS	SWITCHPLATE - PART #4752-112-CD VENETIAN BRONZE		GC SUPPLIED
POS. FRONTBAR CABINET SIDE	PLASTIC LAMINATE - BLACK		

CASEWORK MCS CABINET BASE OPTION SCHEDULE					
DESIGN ID	COUNT	BASE OPTION	DESCRIPTION		
11941	1	Other	CABINET - WARMING CART BASE		
11972	1	Other	CABINET - ESPRESSO - 24IN 610MM		
12007	1	Other	CABINET - SINK OR ICE BIN - 24IN 610MM		
12050	1	Box Base	CABINET - POS BRIDGE FOR SAFE - 22X27IN 560X685MM		
12067	1	Other	CABINET - WARMING WITH TRASH DROP - 12IN 305MM		
12080	3	Other	CABINET - 15IN 380MM		
12082	1	Other	CABINET - CBS ICE BIN - LH - 24IN 610MM		
12096	1	Other	CABINET - WITH DRAWER - 15IN 380MM		
12098	1	Other	CABINET - BREW GRIND - 24IN 610MM		
12111	2	Box Base	CABINET - POS - 22IN 560MM		

RESPONSIBILITY LEGEND

SB - STARBUCKS

GC - GENERAL CONTRACTOR

VD - VENDOR

LL - LANDLORD



STARBUCKS COFFEE

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ARCHITECT OF RECORD

ENGINEER OF RECORD

Engineering Consultant

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PROJECT ADDRESS:
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STORE #: PROJECT #: 14516-022 CONCEPT: NCS

PALETTE: HERITAGE ISSUE DATE: DESIGN MANAGER: S. RYCHLIK $\mathsf{LEED}^{\circledR}\mathsf{AP} :$

PRODUCTION DESIGNER: C. ALINOVICH, NORR CHECKED BY: K. GORIN. NORR

SHEET TITLE:

SCHEDULES

SCALE:

SHEET NUMBER: